



Community Development—Planning

1000 Central Ave, Suite 150 Los Alamos, NM 87544 505.662.8120 planning@lacnm.us

DEVELOPMENT APPLICATION

PROJECT INFORMATION	
Title:	
Project Address:	
Description:	
•	Site Plan* \$500 plus \$75 per/Million \$ estimated construction cost Estimated Construction Cost: Major Site Plan Amendment* \$500 Minor Site Plan Amendment \$250 Major Zone Map Amendment* \$150 No fee if initiated by County Council or County Manager Minor Zone Map Amendment* \$150 No fee if initiated by County Council or County Manager Master Plans* (Major, Minor) \$250 Text Amendment* \$150 No fee if initiated by County Council or County Manager Variance \$250 No fee if application is a part of a Site Plan review Administrative Wireless Telecommunication Facility \$250 Discretionary Wireless Telecommunication Facility* \$500 Small Wireless Facility \$250 Major Historic Demolition* \$250 Major Historic Property Alteration Certification* \$250 Minor Historic Property Alteration Certificate \$250
Lighting Plan\$500	
* Application reviews requi	re a pre-application meeting.

PROPERTY & OWNER INFORMATION			
Property			
Address:	ity	State	ZIP
Zoning District:	Lot Size - Acres / Sq.	Ft.:	
Existing Structure(s) Sq. Ft.:	Lot Coverage:		
Property Owner(s) Name:			
Owner(s) Email:			
Owner(s) Phone(s)#:			
Owner's Address same as Property Address			
Owner(s)			
Address:	City	State	ZIP
APPLICANT / OWNER'S AGENT INFORMATION			
Applicant is same as Owner			
Applicant Name:			
Applicant			
Address:	ity	State	ZIP
Applicant Email:			
Applicant Phone(s)#:			
ASSOCIATED APPLICATIONS			
Application Type:			
Case Number:			
I hereby certify and affirm, under penalty of perjury, the accurate to the best of my knowledge, information, and		•	pplication is true and
Signature: Scott Hopper	Date:		
STAFF USE ONLY			
Date Received:	Staff:		
Case No.#:	Meeting Date:		
SUBMITTALS			
Proof of Ownership orLetter of Authorization from OwnerItems from associated Application Checklist	Complete Applicat Payment – Accepte application - Dates	ed upon verification o	 of a complete




Community Development-Planning

1000 Central Ave, Suite 150 Los Alamos, NM 87544 505.662.8120 planning@lacnm.us

VARIANCE CHECKLIST

Applicants for all development application reviews must complete this checklist and submit it with the Development Application. Refer to the referenced code sections for additional information. Contact the Planning Division with questions regarding these requirements: planning@lacnm.us.

PRE-APPLICATION MEETING Date Held: **SITE PLAN** Scaled site plan at a minimum of 1" = 100' that illustrates the following: Graphic Scale and North Arrow Property Lines according to recorded survey Existing and proposed structures Existing and proposed easements Existing and proposed setbacks Existing and proposed utility lines **ELEVATIONS** Elevation drawing(s) at a minimum scale of 1/8" = 1' that indicates: Height (above existing grade) of all four sides **LOT COVERAGE** Existing (%): Proposed (%): **ADDITIONAL SUBMITTALS** Based on staff's review and Interdepartmental Review Committee's recommendation – additional submittals may be required and will be communicated to the applicant by the assigned Case Manager.

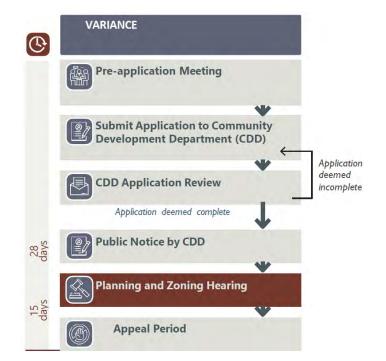

See Reverse.

DECISION CRITERIA 16-74-(g)(3) a. The variance will not be contrary to the public safety, health, or welfare. Explain. Staff finds that this criterion has been met Staff finds that this criterion has not been met – more information is needed b. The variance request will not undermine the intent of the Development Code, the applicable zone district, other County adopted policies or plans, or violate the Building Code. Explain. ☐ Staff finds that this criterion has been met Staff finds that this criterion has not been met – more information is needed c. Granting of the variance will not cause an intrusion into any utility or other easements unless approved by the owner of the easement. Explain. Staff finds that this criterion has been met Staff finds that this criterion has not been met – more information is needed

	DECISION CRITERIA 16-74-(g)(3)
d.	The variance request is caused by an unusual physical characteristic or hardship inherent in the lot or lot improvements and that the peculiarity or hardship is not self-imposed. Explain.
	Staff finds that this criterion has been met Staff finds that this criterion has not been met – more information is needed
e.	The variance will not create any significant adverse impacts on properties within the vicinity. Explain.
	☐ Staff finds that this criterion has been met ☐ Staff finds that this criterion has not been met – more information is needed
f.	Granting of the approved variance is the minimum necessary easing of the Code requirements making possible the reasonable use of the land, structure, or building. Explain.
	Staff finds that this criterion has been met
-	Staff finds that this criterion has not been met – more information is needed

Attach additional sheets, if needed.



Community Development—Planning

1000 Central Ave, Suite 150 Los Alamos, NM 87544 505.662.8120 planning@lacnm.us

Case No.	

OWNER AFFIDAVIT

(Authorizing an agent to act on behalf of a property owner when making a land development application.)

STATE OF NEW MEXICO)	
COUNTY OF LOS ALAMOS)	
Say that (I am) (we are) the owner(s) of property located 580 OVERLOOK RD. WHITE ROCK, NM 87544 (OTTRACT N, WHITE ROCK SUBDIVISION, AS SHOW SEPTEMBER 3, 1965 IN BOOK 1, PAGE 62, AND A RECORDED ON AUGUST 30, 1966 IN BOOK 7, PAGE COUNTY, NEW MEXICO, for which (I am) (we are) to Telecommunication Facility (conditional use permits; so variance; zone change; subdivision; summary plat; temphistoric property; or development plans) through the Country of the conditional matters pertaining to this application. Signed: Anne Laurent Address: 1000 Central Ave. Ste.350	verlook Park), legally described as: VN ON PLAT RECORDED FFIDAVIT OF CORRECTION GE 141, RECORDS OF LOS ALAMOS requesting a: ketch, preliminary and final plats; site plan; porary use permit; telecommunication facility; county of Los Alamos, New Mexico.
Los Alamos, NM 87544 Telephone: 505-603-1750	Telephone:
Subscribed and sworn to before me this ab day of Ausst, 20 24. Notary Public My Commi	STATE OF NEW MEXICO NOTARY PUBLIC Jacqueline D. Salazar Commission Number 1102101 My Commission Expires May 24, 2025



SUN STATE

NM14-149 GRAND SLAM / NM4 OVERLOOK

APN: 104-01-0825-1495

580 OVERLOOK RD.

LOS ALAMOS, NM 87544 LOS ALAMOS COUNTY

VICINITY MAP

DEPART ALBUQUERQUE INTERNATIONAL AIRPORT, HEAD SOUTH ON YALE BLVD SE, SLIGHT LEFT TO STAY ON YALE BLVD SE, MERGE ONTO SUNPORT BLVD. SLIGHT RIGHT TO STAY ON SUNPORT BLVD. KEEP LEF TO STAY ON SUNPORT BLVD. USE THE LEFT LANE TO MERGE ONTO SUNPORT LOOP SE, KEEP LEFT TO CONTINUE ON SUNPORT BLVD, USE THE RIGHT 2 LANES TO MERGE ONTO I-25 N VIA THE RAMP TO I-40. N/DOWNTOWN/SANTA FE. MERGE ONTO I-25 N. TAKE EXIT 276 FOR NM-599 S TOWARD MADRID. USE THE LEFT 2 LANES TO TURN LEFT ONTO NM-599 N. TAKE THE US-84 N/US-285 EXIT ON THE LEFT TOWARD ESPAÑOLA. MERGE ONTO US-285 N/US-84 W. TAKE THE NM-502 W/LOS ALAMOS EXIT. MERGE ONTO LOS ALAMOS HWY. CONTINUE ONTO NM-502. USE THE RIGHT 2 LANES TO TAKE THE NM-4 RAMP TO WHITE ROCK/BANDELIER NATL MON. CONTINUE ONTO NM-4 W. TURN LEFT ONTO ROVER BLVD. TURN LEFT ONTO MEADOW LN. TURN LEFT ONTO OVERLOOK RD. DESTINATION WILL BE ON THE LEFT.

OVERLOOK RD.

ROJECT DESCRIPTION

SCOPE OF WORK

- INSTALL PROPOSED 80'-0" SUN STATE TOWERS GALVANIZED STEEL MONOPOLE
- INSTALL PROPOSED 20'-0"X30'-0" SPLIT FACE CMU WALL W/ SLOPPED SECURITY TOPPER
- INSTALL PROPOSED 4'-0"X12'-0" CONCRETE PAD
- INSTALL PROPOSED BATTERY CABINET
- INSTALL PROPOSED RF CABINET INSTALL PROPOSED GPS ANTENNA
- INSTALL (9) PROPOSED 4"Ø UNDERGROUND CONDUITS
- INSTALL PROPOSED ELECTRICAL SERVICE
- INSTALL PROPOSED TELCO SERVICE
- INSTALL PROPOSED ANTENNA FRAME INSTALL [9] PROPOSED ANTENNAS
- INSTALL [9] PROPOSED REMOTE RADIO HEADS
- INSTALL [1] PROPOSED 12-PORT OVP
- INSTALL [2] PROPOSED HYBRIFLEX CABLES

VERIZON WIRELESS 6955 W MORELOS PL CHANDLER, AZ 85226

- OVERALL SITE PLAN Z-1
- Z-4 PROPOSED SITE PLAN
- Z-5 ENLARGED SITE PLAN AND ANTENNA PLAN
- Z-7 ELEVATIONS

SHEET INDEX

- PROJECT INFORMATION
- Z-2 OVERALL SETBACK PLAN
- Z-3 EXISTING SITE PLAN
- Z-6
- ELEVATIONS
- COMPOUND ENCLOSURE DETAIL

PROPERTY OWNER: LOS ALAMOS COUNTY 1000 CENTRAL AVE. LOS ALAMOS. NM 87544 PHONE: [505] 662-8333

CLIENT / TOWER OWNER:

1426 N. MARVIN STREET #101

SUN STATE TOWERS

CONTACT: CHAD WARD

PHONE: [480] 664-9588

GII BERT A7 85233

CARRIER:

CONTACT: JEFF DEWALT PHONE: [505] 332-6007

SITE ACQUISITION:

PINNACLE CONSULTING, INC. 1426 N. MARVIN STREET #101 GILBERT, AZ 85233 CONTACT: MICHELLE JOHNSON PHONE: (480) 664-9588 ext. 230

ENGINEERING FIRM:

PINNACLE CONSULTING, INC. 1426 N. MARVIN STREET #101 GILBERT, AZ 85233 ENGINEER: KYLE FORTIN, PE PHONE: [623] 217-4235

PARCEL #:

104-01-0825-1495 USE: UNMANNED COMMUNICATIONS

NEW LEASE AREA: 2200 SQ. FT

JURISDICTION: LOS ALAMOS COUNTY

GOVERNING CODES: 2021 IBC, 2021 NMBC, 2015 NFPA 1

2020 NMEC

ALL BUILDING CODES LISTED ABOVE SHALL INCLUDE AMENDMENTS BY THE GOVERNING JURISDICTION

GENERAL NOTES

- THIS WIRELESS TELECOMMUNICATIONS FACILITY WILL MEET THE HEALTH AND SAFETY STANDARDS FOR ELECTROMAGNETIC FIELD EMISSIONS AS ESTABLISHED BY THE FEDERAL COMMUNICATIONS COMMISSION OR ANY SUCCESSOR THEREOF, AND ANY OTHER FEDERAL OR STATE AGENCY.
- 2. THIS WIRELESS TELECOMMUNICATIONS FACILITY WILL MEET THE REGULATIONS OF THE FEDERAL COMMUNICATIONS COMMISSION REGARDING PHYSICAL AND ELECTROMAGNETIC INTERFERENCE.
- 3. LIGHTING OR SIGNS WILL BE PROVIDED ONLY AS REQUIRED BY FEDERAL OR STATE AGENCIES
- 4 DEVELOPMENT AND CONSTRUCTION OF THIS PROJECT WILL COMPLY WITH ALL APPLICABLE CODES AND ORDINANCES.
- 5. EXISTING PARKING IS NOT AFFECTED BY THIS PROJECT.
- 6. THIS PROJECT DOES NOT INCLUDE WATER OR SEWER.
- 7. THIS PROJECT INCLUDES C-BAND INSTALLATION
- 8. NO ABANDONMENT OF A SMALL WIRELESS FACILITY SHALL BE PERMITTED. ALL SMALL WIRELESS FACILITIES NOT IN SERVICE SHALL BE PHYSICALLY MAINTAINED AS IF IN SERVICE FOR THE PROTECTION AND SAFETY OF THE PUBLIC.

APPROVALS

DATE:

COORDINATES

TOWER COORDINATES:

TOWER LATITUDE 35.826752° 35° 49' 36.31" N [NAD83] TOWER LONGITUDE -106.188301° -106° 11' 17.89" W [NAD83] TOWER GROUND ELEVATION

FIBER MMP (MEET ME POINT) COORDINATES:

MMP LATITUDE 35.826074° 35° 49' 33.87" N [NAD83] MMP LONGITUDE -106.188313° -106° 11' 17.93" W [NAD83]

DATE:

DATE:

LANDLORD: DATE:

PREPARED FOR

1426 NORTH MARVIN STREET #101 GII BERT AZ 85233

2600 W. GERONIMO PL., CHANDLER, AZ 85224 PHONE: (480) 777-4360 FAX: (480) 777-4391

A&E CONSULTING FIRM & SITE ACQUISITION



PROJECT NO NM14-149 GRAND SLAN DRAWN BY: CHECKED BY:

REV DATE DESCRIPTION BY 4 02/18/25 FINAL ZONING CS 5 03/12/25 FINAL ZONING CS				
	REV	DATE	DESCRIPTION	BY
5 03/12/25 FINAL ZONING CS	4	02/18/25	FINAL ZONING	cs
	5	03/12/25	FINAL ZONING	cs





NM14-149 GRAND SLAM NM4 OVERLOOK

580 OVERLOOK RD LOS ALAMOS, NM 87544 LOS ALAMOS COUNTY

SHEET TITLE

PROJECT INFORMATION

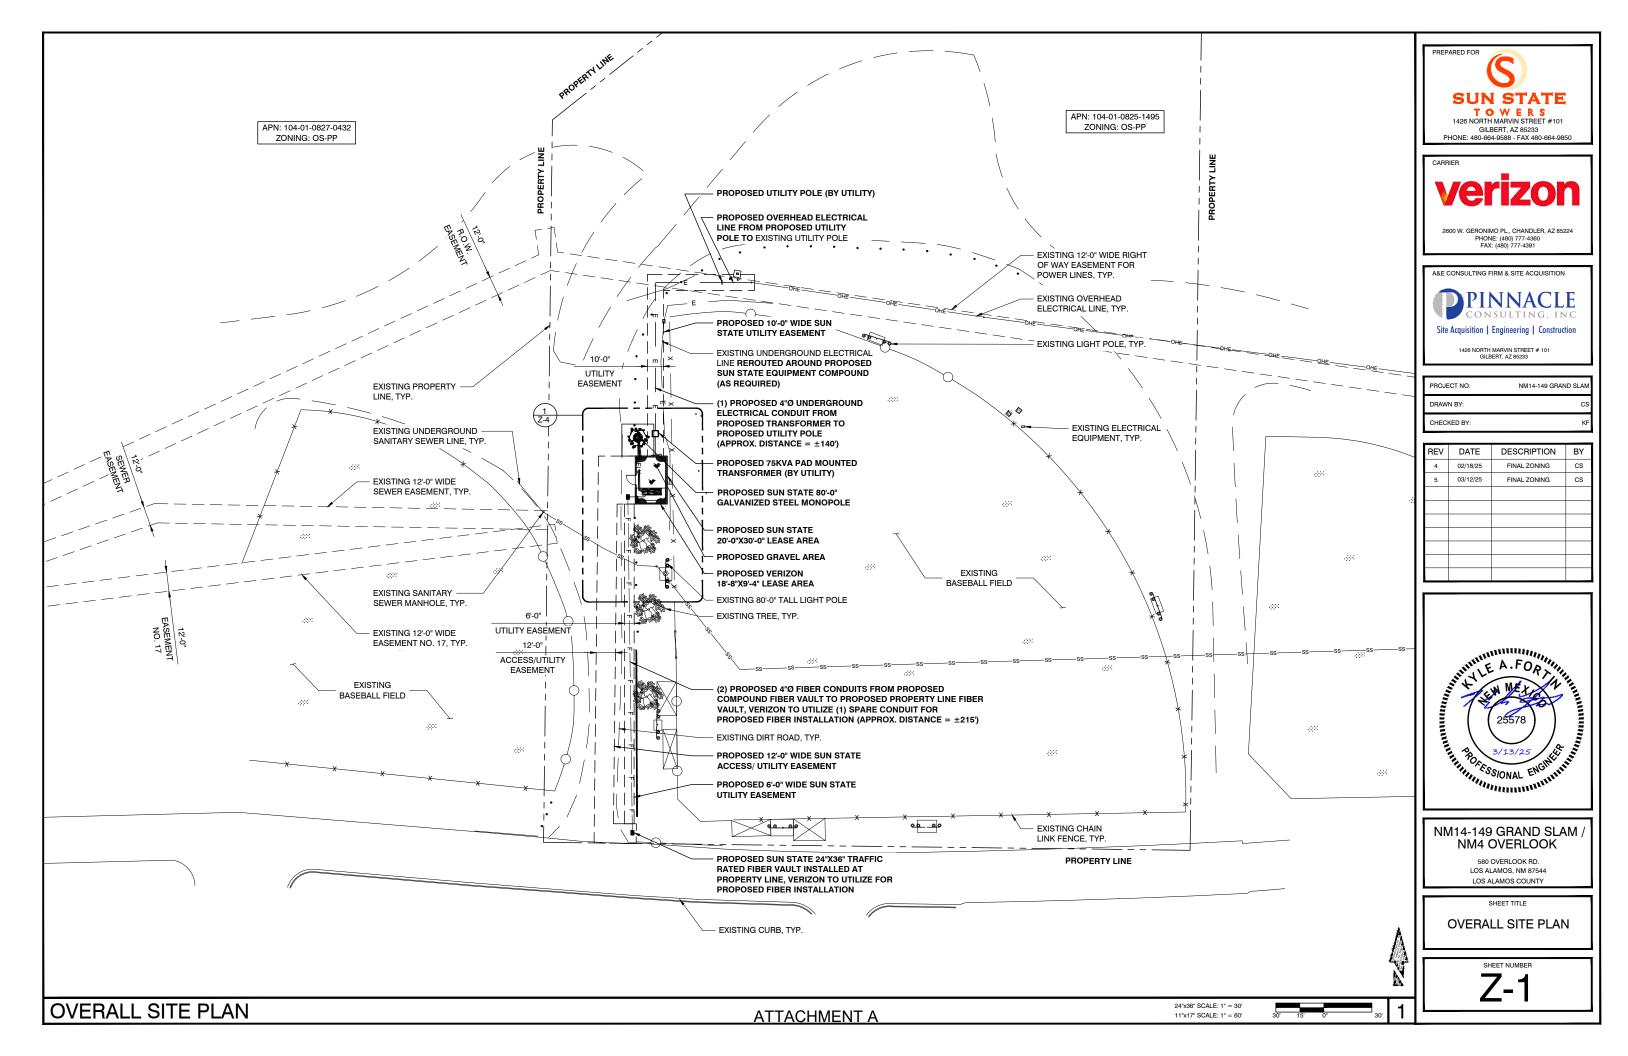

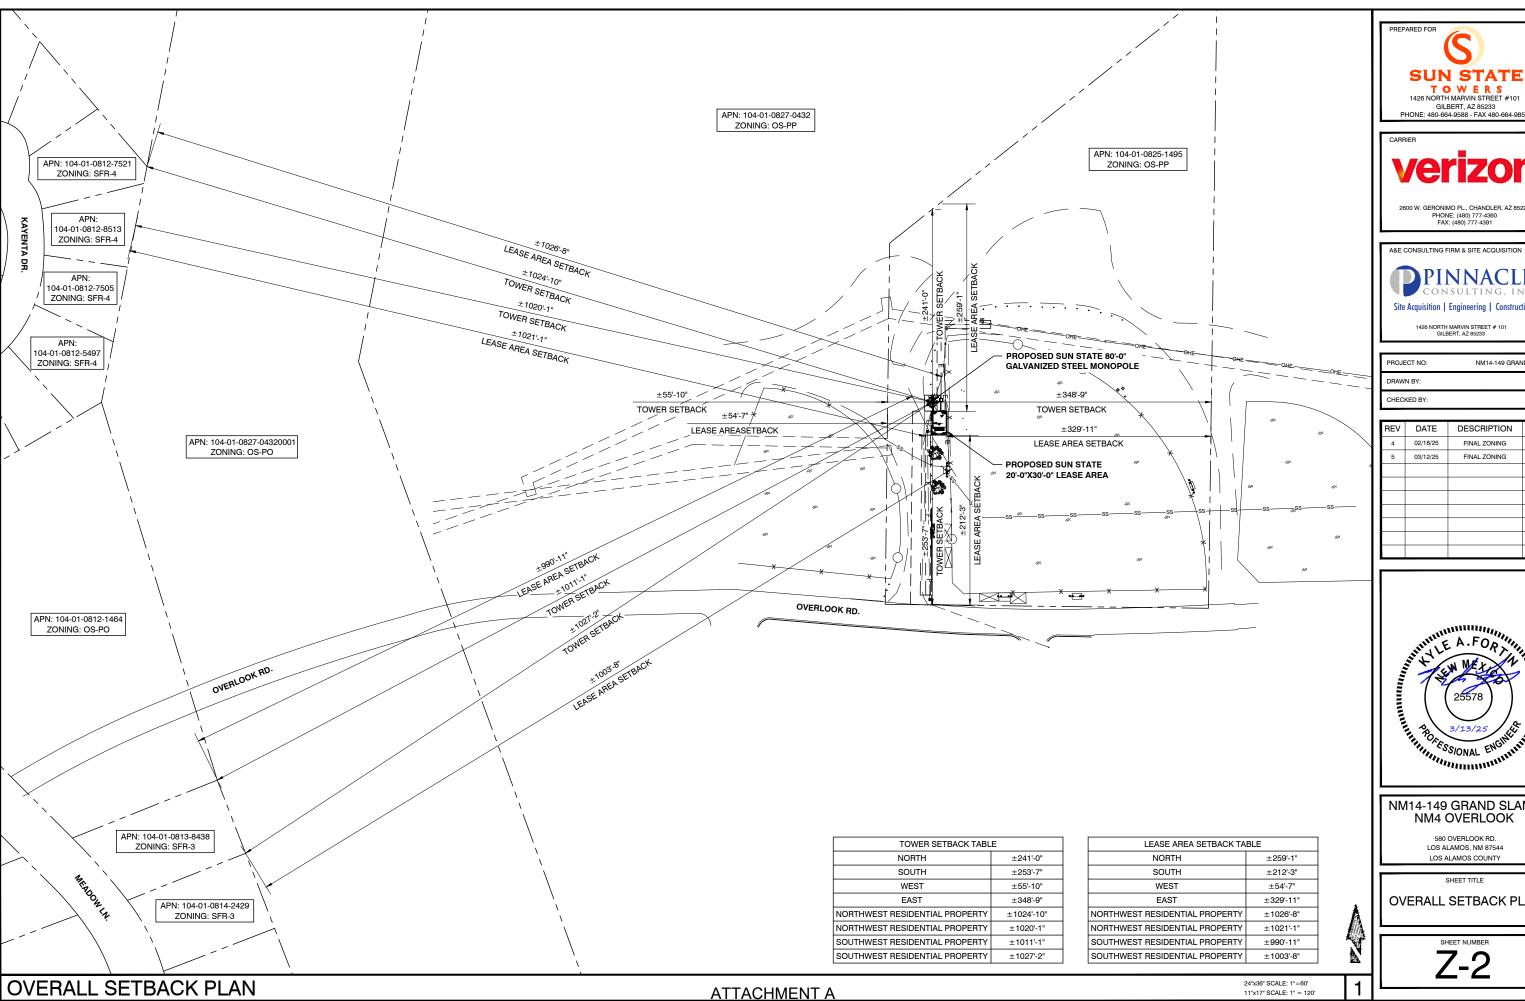

PREPARED FOR **SUN STATE** TOWERS
1426 NORTH MARVIN STREET #101

GILBERT, AZ 85233 PHONE: 480-664-9588 - FAX 480-664-9850


2600 W. GERONIMO PL., CHANDLER, AZ 85224 PHONE: (480) 777-4360 FAX: (480) 777-4391



1426 NORTH MARVIN STREET # 101 GILBERT, AZ 85233

PROJECT NO:	NM14-149 GRAND SLAM	
DRAWN BY:	cs	
CHECKED BY:	KF	

REV	DATE	DESCRIPTION	BY
4	02/18/25	FINAL ZONING	CS
5	03/12/25	FINAL ZONING	CS

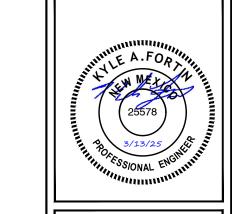


NM14-149 GRAND SLAM NM4 OVERLOOK

580 OVERLOOK RD. LOS ALAMOS, NM 87544 LOS ALAMOS COUNTY

SHEET TITLE

OVERALL SETBACK PLAN


Z-2

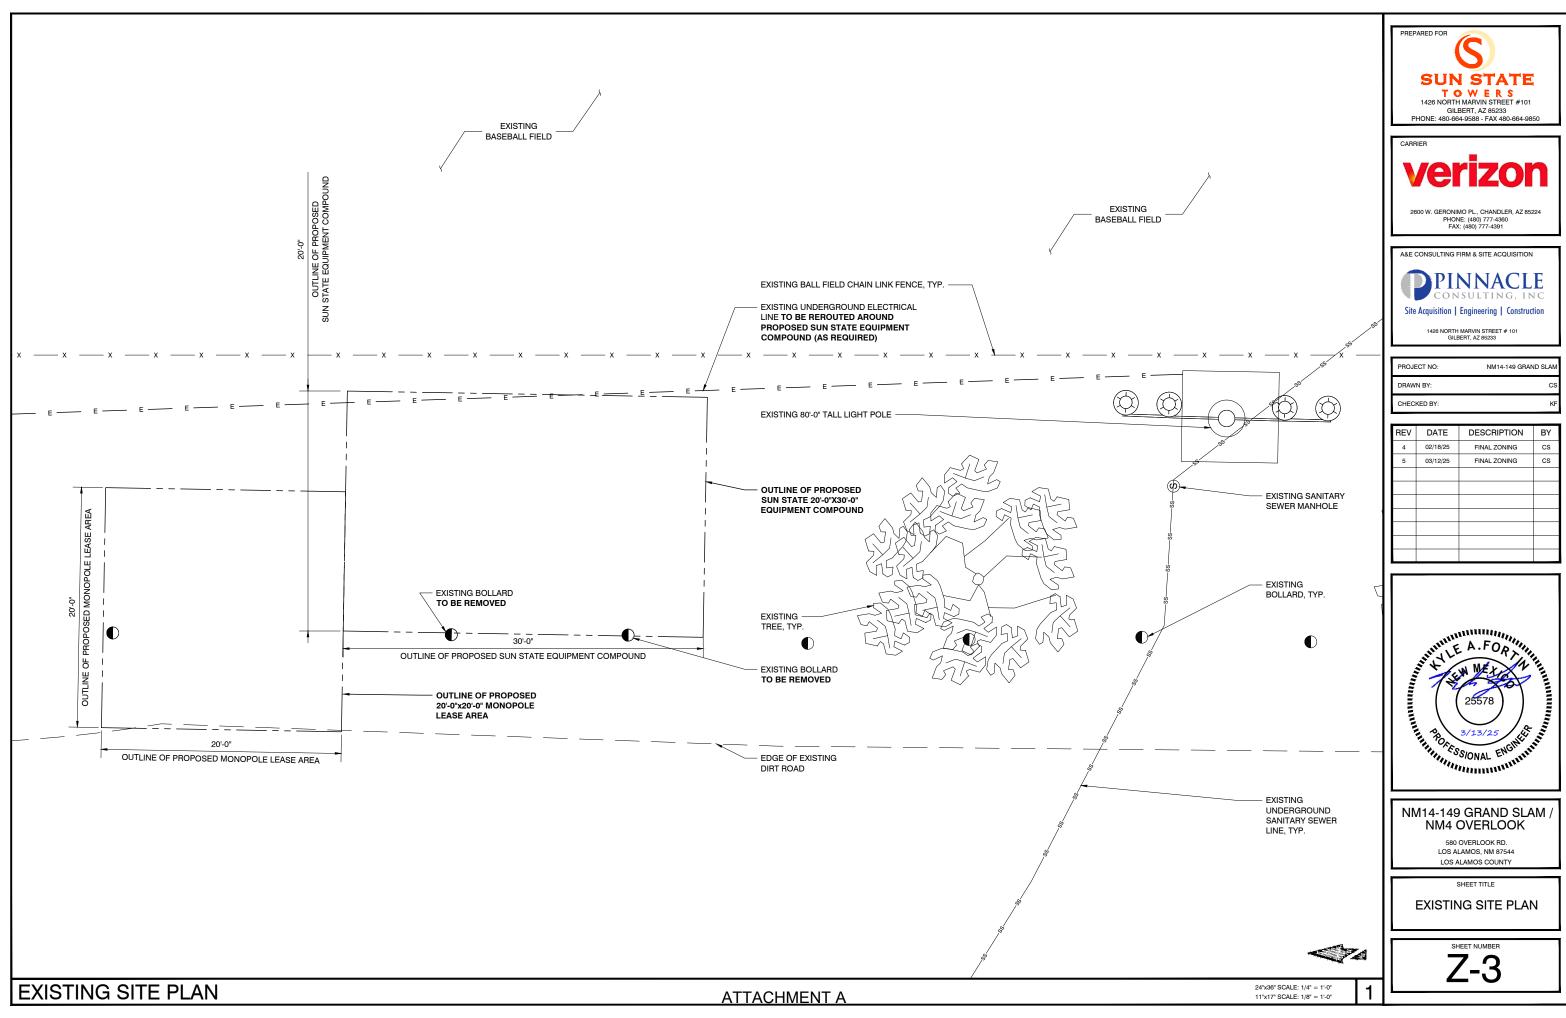







NM14-149 GRAND SLAN

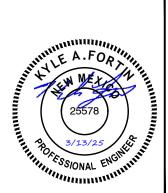

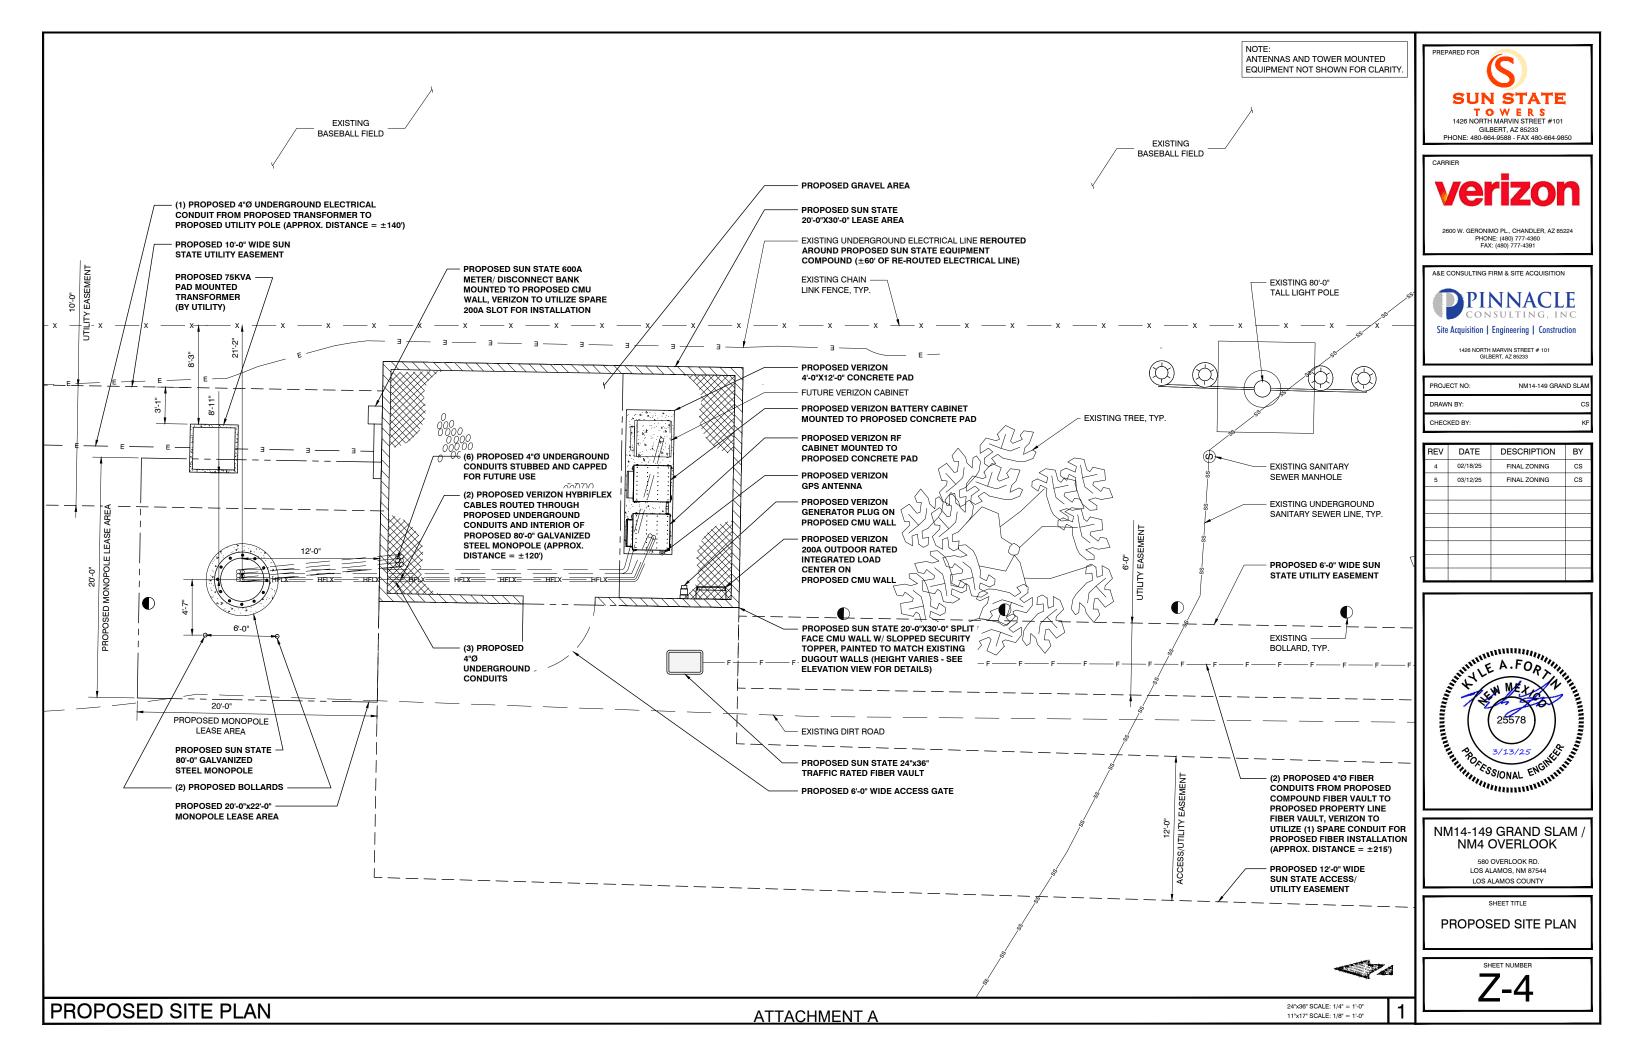

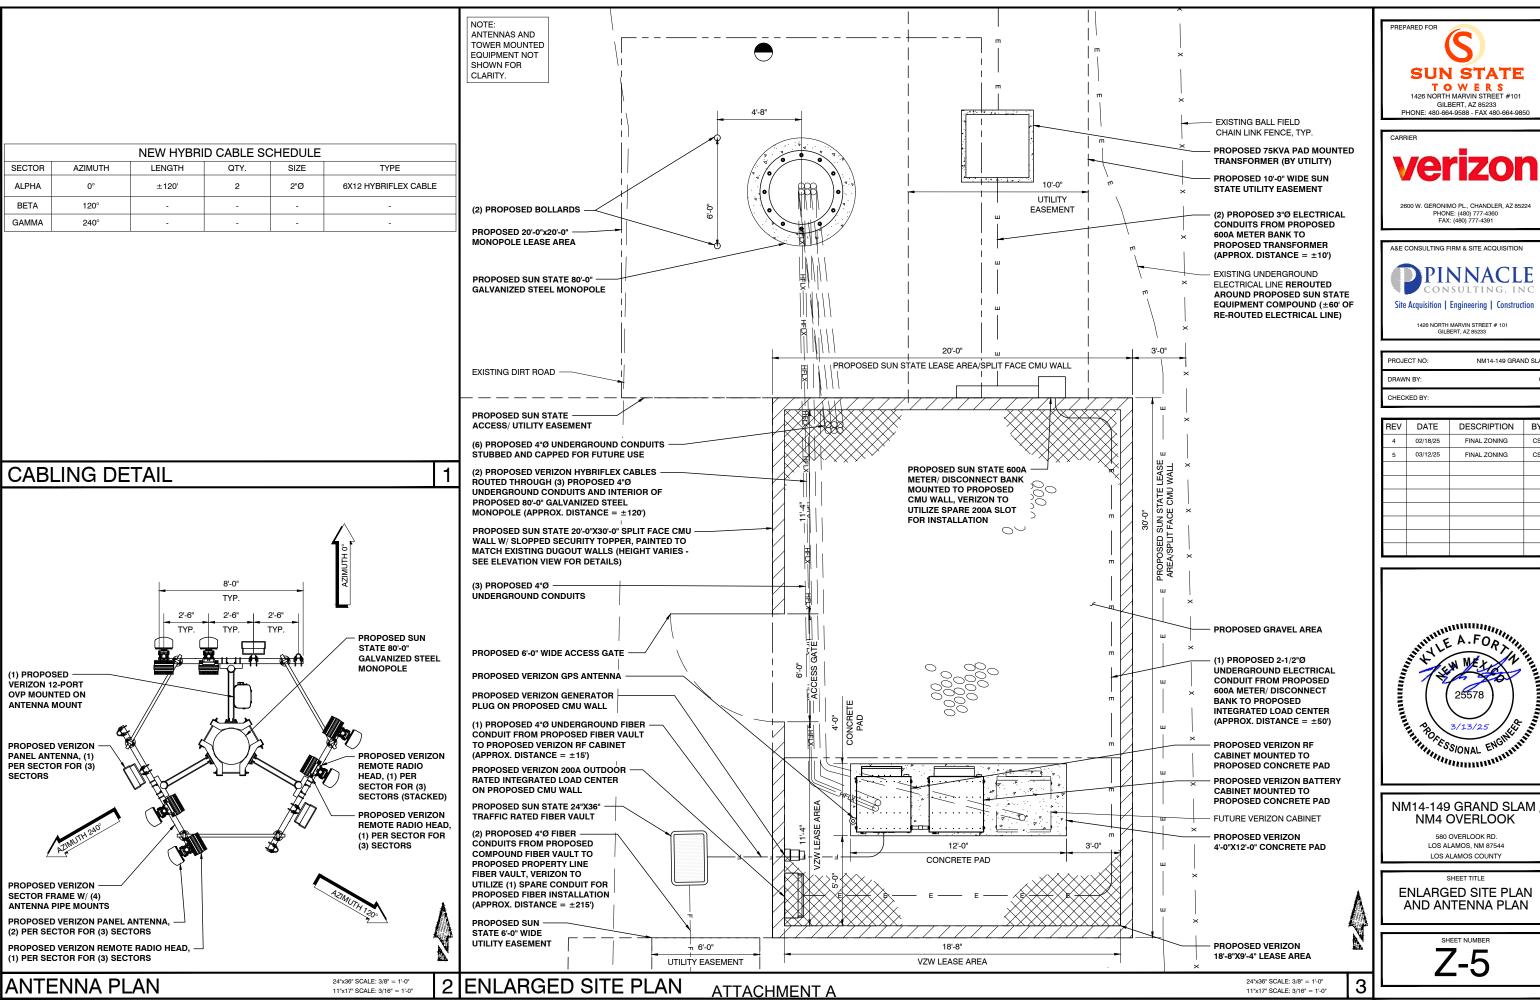

2600 W. GERONIMO PL., CHANDLER, AZ 85224

PINNACLE


NM14-149 GRAND SLA

REV	DATE	DESCRIPTION	BY
4	02/18/25	FINAL ZONING	CS
5	03/12/25	FINAL ZONING	CS



NM14-149 GRAND SLAM NM4 OVERLOOK

AND ANTENNA PLAN

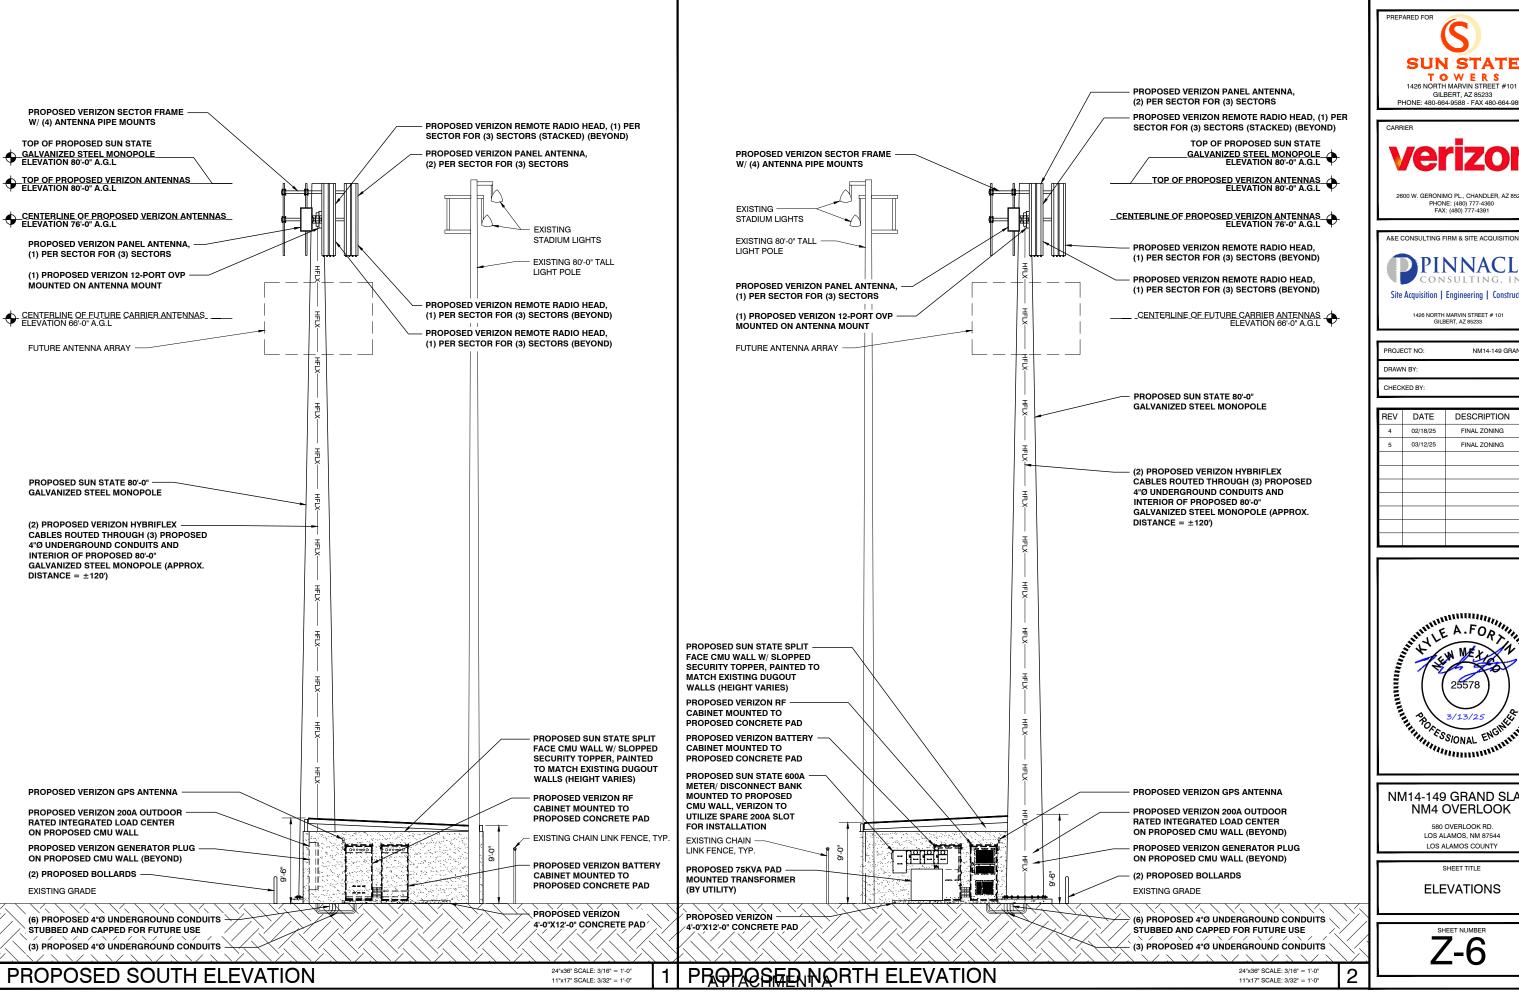



GILBERT, AZ 85233 PHONE: 480-664-9588 - FAX 480-664-9850

erizon


2600 W. GERONIMO PL., CHANDLER, AZ 85224 PHONE: (480) 777-4360 FAX: (480) 777-4391

PINNACLE Site Acquisition | Engineering | Construction

1426 NORTH MARVIN STREET # 101 GILBERT, AZ 85233

PROJECT NO NM14-149 GRAND SLA CHECKED BY:

REV	DATE	DESCRIPTION	BY
4	02/18/25	FINAL ZONING	CS
5	03/12/25	FINAL ZONING	CS

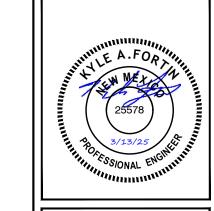


NM14-149 GRAND SLAM / NM4 OVERLOOK

> 580 OVERLOOK RD LOS ALAMOS, NM 87544 LOS ALAMOS COUNTY

> > SHEET TITLE

ELEVATIONS

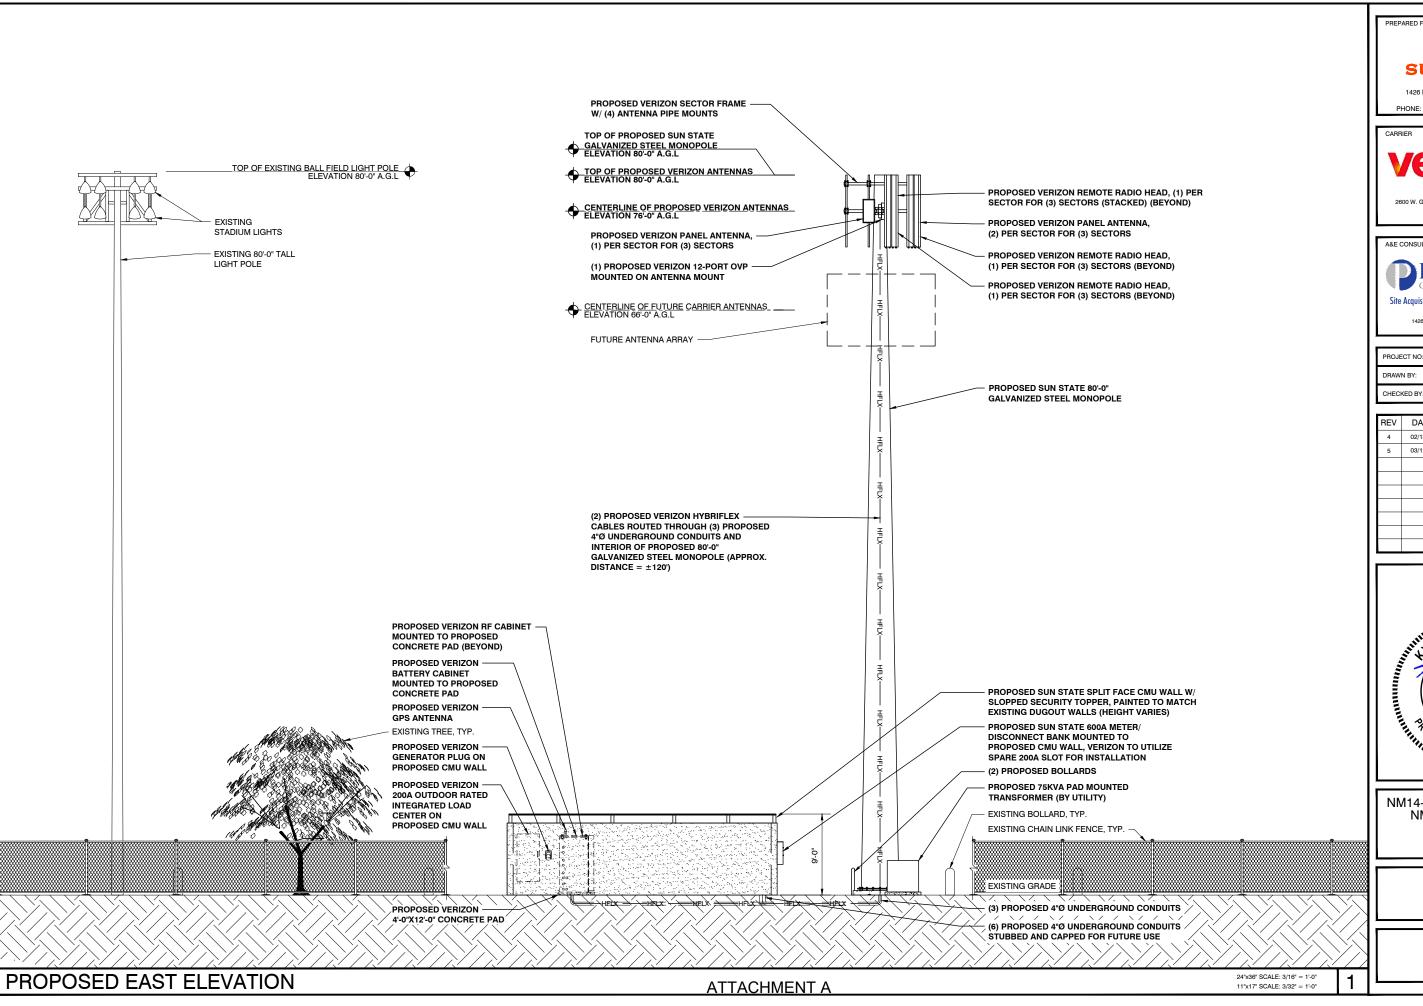



GILBERT, AZ 85233 PHONE: 480-664-9588 - FAX 480-664-9850

verizon

2600 W. GERONIMO PL., CHANDLER, AZ 85224 PHONE: (480) 777-4360 FAX: (480) 777-4391


A&E CONSULTING FIRM & SITE ACQUISITION



1426 NORTH MARVIN STREET #

PROJECT NO: NM14-149 GRAND SLAM
DRAWN BY: CS

REV	DATE	DESCRIPTION	BY
4	02/18/25	FINAL ZONING	CS
5	03/12/25	FINAL ZONING	cs

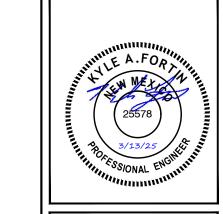


NM14-149 GRAND SLAM / NM4 OVERLOOK

> 580 OVERLOOK RD. LOS ALAMOS, NM 87544 LOS ALAMOS COUNTY

> > SHEET TITLE

ELEVATIONS

Z-7

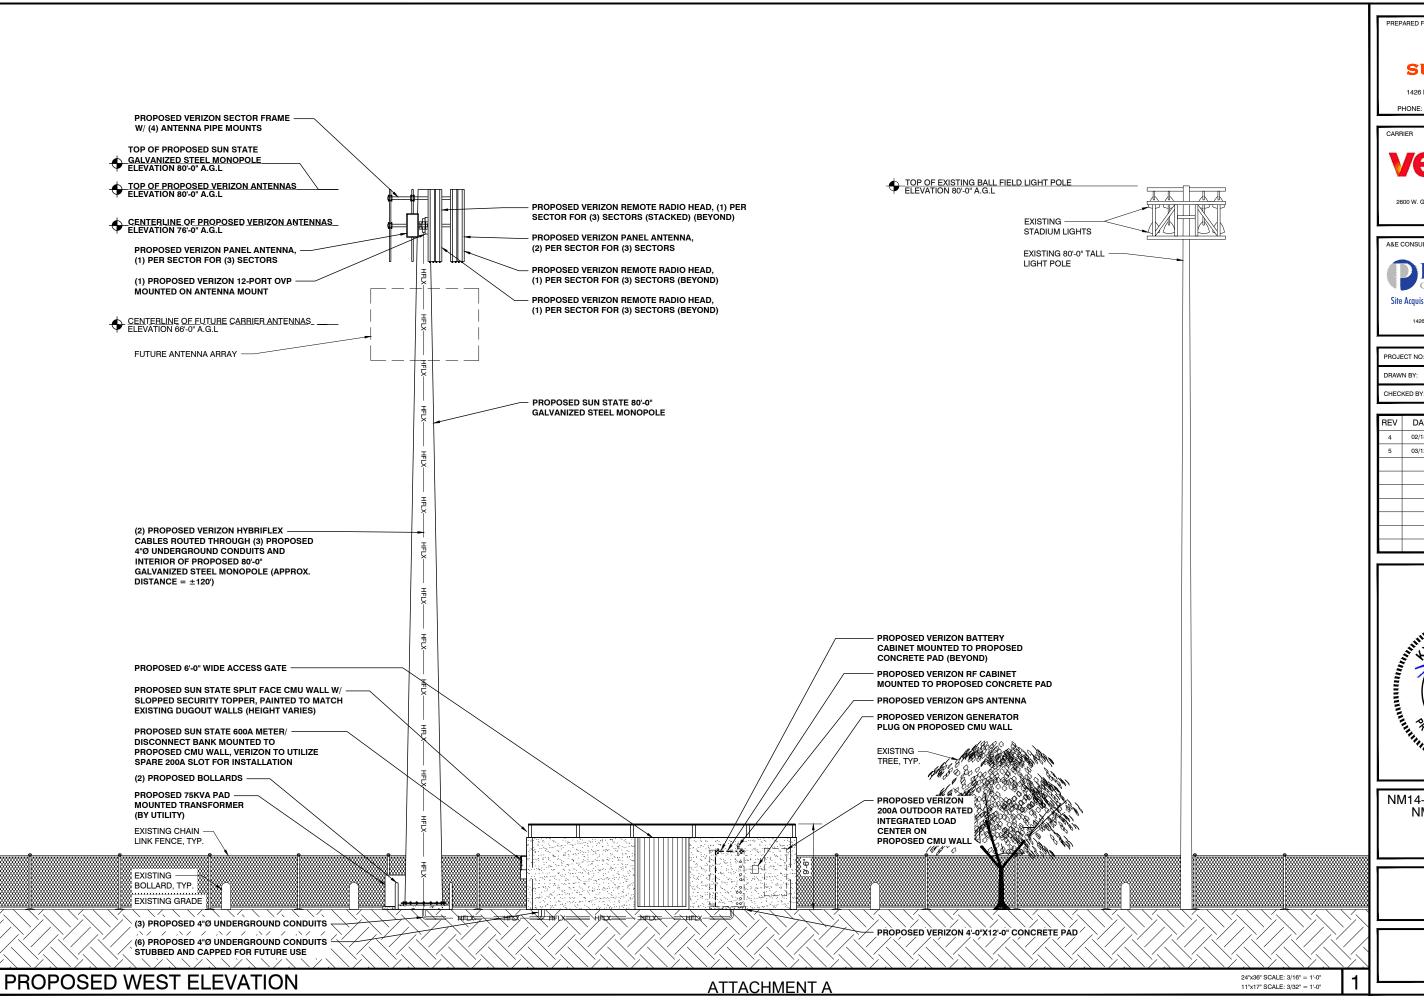



GILBERT, AZ 85233 PHONE: 480-664-9588 - FAX 480-664-9850

2600 W. GERONIMO PL., CHANDLER, AZ 85224 PHONE: (480) 777-4360 FAX: (480) 777-4391


A&E CONSULTING FIRM & SITE ACQUISITION



1426 NORTH MARVIN STREET # 101 GILBERT, AZ 85233

PROJECT NO: NM14-149 GRAND SLAN DRAWN BY:

REV	DATE	DESCRIPTION	BY
4	02/18/25	FINAL ZONING	cs
5	03/12/25	FINAL ZONING	cs

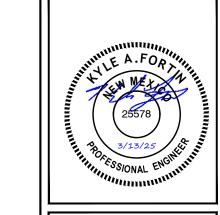

NM14-149 GRAND SLAM/ NM4 OVERLOOK

580 OVERLOOK RD. LOS ALAMOS, NM 87544 LOS ALAMOS COUNTY

SHEET TITLE

ELEVATIONS

MASONRY NOTES:

MASONRY WALL GENERAL NOTES

2021 NEW MEXICO COMMERCIAL BUILDING CODE

104 MPH ULTIMATE DESIGN WIND SPEED (RISK CATEGORY II) EXPOSURE C

SEISMIC:

RISK CATEGORY II SITE CLASS: C SEISMIC DESIGN CATEGORY C Ss = 0.495S1 = 0.161

GEOTECHNICAL

FOUNDATION DESIGN IN ACCORDANCE WITH RECOMMENDATIONS PROVIDED IN GEOTECHNICAL REPORT NO.: 2022130.36

BY GDP GROUP

DATED JANUARY 24, 2023

ALLOWABLE BEARING PRESSURE = 3000PSF

AT 2'-6" BELOW LOWEST ADJACENT FINISHED GRADE. REFER TO SOILS REPORT FOR ADDITIONAL INFORMATION.

CONCRETE:

CONSTRUCTION SHALL BE IN ACCORDANCE WITH ACI 318. CONCRETE SHALL HAVE A MINIMUM COMPRESSIVE STRENGTH OF 2500 PSI AT 28 DAYS. VIBRATE REINFORCED CONCRETE DURING PLACEMENT.

DEFORMED REINFORCING BARS SHALL CONFORM TO ASTM A615, GRADE 60. ALI REINFORCING SHALL BE SECURELY TIED TO PREVENT MOVEMENT WHILE PLACING CONCRETE. WELDING OF REINFORCING IS NOT ALLOWED. LAP REINFORCING 48 BAR DIAMETERS (30" FOR #5, 24" FOR #4). BEND REINFORCING OR PROVIDE CORNER BARS WHERE FOOTING CHANGES DIRECTION.

MINIMUM CONCRETE COVER FOR REINFORCING STEEL CAST IN CONCRETE (UNO): CAST AGAINST EARTH:

PERMANENTLY EXPOSED TO EARTH OR WEATHER: 1 1/2" (#5 AND SMALLER) 2" (#6 AND LARGER)

MASONRY:

CONCRETE MASONRY UNITS (CMU) SHALL CONFORM TO ASTM C90, LOAD BEARING WITH A MINIMUM COMPRESSIVE STRENGTH OF 1900 PSI (NET AREA).

MORTAR SHALL CONFORM TO ASTM C-270, TYPE S.

FILL ALL REINFORCED CELLS WITH 2000 PSI GROUT OR GROUT CONFORMING TO ASTM C476. MAXIMUM GROUT POUR IS 5'-4" WITHOUT CLEANOUTS. MECHANICALLY CONSOLIDATE GROUT AFTER PLACEMENT AND RECONSOLIDATE AFTER APPROXIMATELY 5 MINUTES. SOLID GROUT ALL CELLS BELOW FINISHED

PROVIDE MASONRY CONTROL JOINTS AT 24' O.C. MAXIMUM WITH A MINIMUM WALL SEGMENT LENGTH OF 8'.

DEFORMED BAR REINFORCING SHALL CONFORM TO ASTM A615, GRADE 60. LAP 48 BAR DIAMETERS (30" FOR #5, 24" FOR #4).

VERTICAL REINFORCING SHALL BE #5, CENTERED IN CELL AT SPACING NOTED ON DRAWING OR AT 48" O.C. MINIMUM. PROVIDE VERTICAL BARS AT ALL WALL ENDS CORNERS, INTERSECTIONS AND EACH SIDE OF CONTROL JOINTS. ALL VERTICAL BARS SHALL BE DOWELED INTO CONCRETE FOOTING WITH A MINIMUM 30"

HORIZONTALLY REINFORCE WALLS WITH (1) #5 IN 8" DEEP SOLID GROUTED BOND BEAM AT TOP OF WALL. PROVIDE BENT CORNER BARS TO MATCH BOND BEAM REINFORCING AT ALL CORNERS. PROVIDE 9 GAUGE (W1.7) GALVANIZED LADDER TYPE HORIZONTAL JOINT REINFORCING CONFORMING TO ASTM A951 AT 16" O.C. VERTICALLY MAXIMUM.


SPECIAL INSPECTIONS:

SPECIAL INSPECTIONS REQUIRED PER IBC CHAPTER 17 FOR THE FOLLOWING ITEMS CONCRETE:

> • PERIODIC INSPECTION TO VERIFY FOUNDATION SIZE AND REINFORCING SIZE & PLACEMENT

MASONRY

- PERIODIC INSPECTION TO VERIFY CMU CONSTRUCTION AND REINFORCING SIZE & PLACEMENT
- CONTINUOUS INSPECTION DURING PLACEMENT OF GROUT

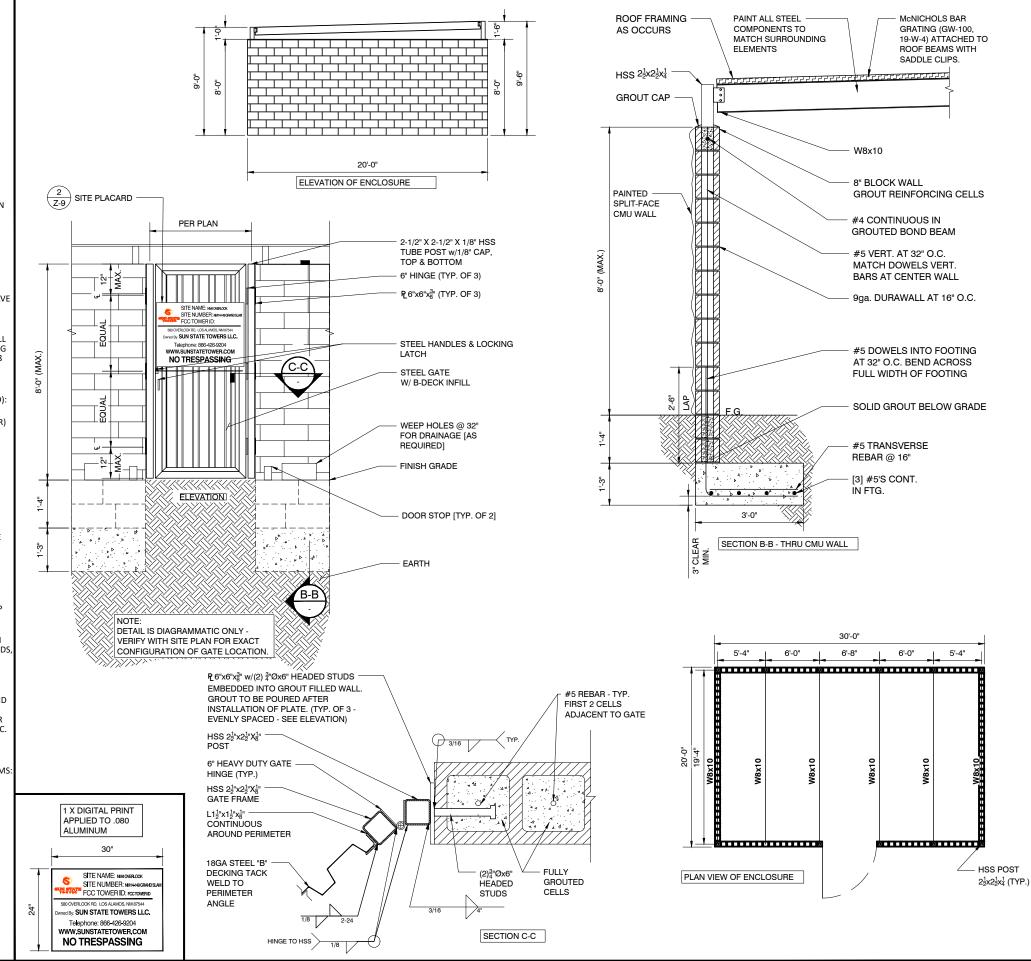



GII BERT AZ 85233 PHONE: 480-664-9588 - FAX 480-664-9850

2600 W. GERONIMO PL., CHANDLER, AZ 85224 PHONE: (480) 777-4360 FAX: (480) 777-4391

A&F CONSULTING FIRM & SITE ACQUISITION PINNACLE Site Acquisition | Engineering | Construction

PROJECT NO NM14-149 GRAND SLA DRAWN BY: CHECKED BY

REV	DATE	DESCRIPTION	BY
4	02/18/25	FINAL ZONING	cs
5	03/12/25	FINAL ZONING	cs



NM14-149 GRAND SLAM NM4 OVERLOOK

580 OVERLOOK RD LOS ALAMOS, NM 87544 LOS ALAMOS COUNTY

SHEET TITLE

COMPOUND ENCLOSURE **DETAIL**

Z-9

SIGN DETAIL

2

COMPOUND ENCLOSEURE DETAIL

SUN STATE

Address: 580 Overlook Rd. ~ Los Alamos, NM 87544 01/03/2025 View 1







These depictions are for demonstrative purposes only.

They are to be used in addition to the engineering drawings for an accurate representation of the site

Applicant

Sun State Towers


1426 North Marvin Street, Suite 101 Gilbert, AZ 85233



SUN STATE

Address: 580 Overlook Rd. ~ Los Alamos, NM 87544 01/03/2025 View 2



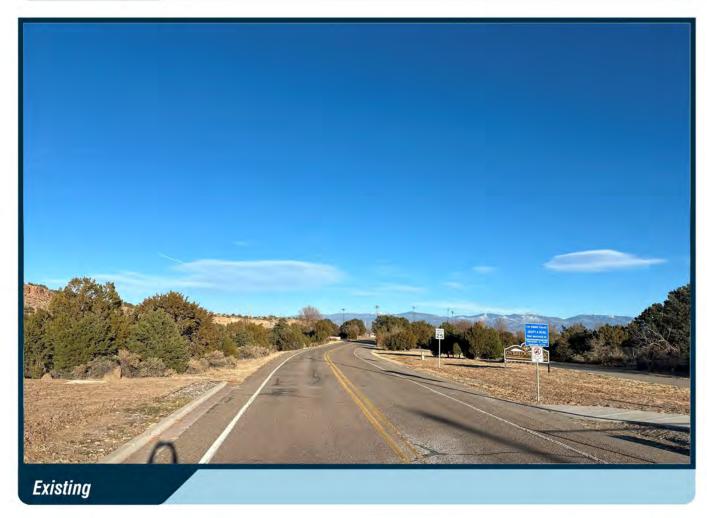



These depictions are for demonstrative purposes only.

They are to be used in addition to the engineering drawings for an accurate representation of the site

Applicant

Sun State Towers

1426 North Marvin Street, Suite 101 Gilbert, AZ 85233




SUN STATE

Address: 580 Overlook Rd. ~ Los Alamos, NM 87544 01/03/2025 View 3





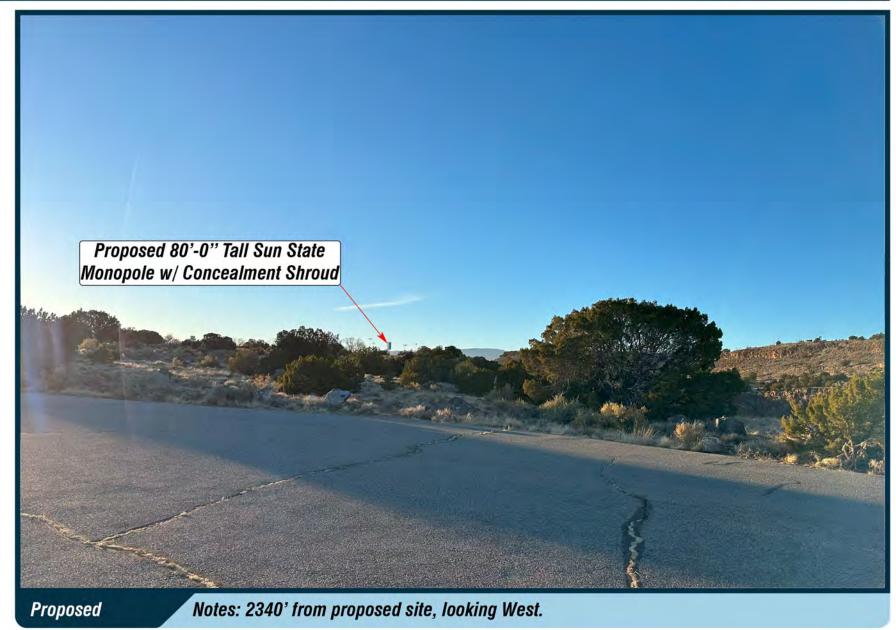

These depictions are for demonstrative purposes only.

They are to be used in addition to the engineering drawings for an accurate representation of the site

Applicant

Sun State Towers


1426 North Marvin Street, Suite 101 Gilbert, AZ 85233



SUN STATE

Address: 580 Overlook Rd. ~ Los Alamos, NM 87544



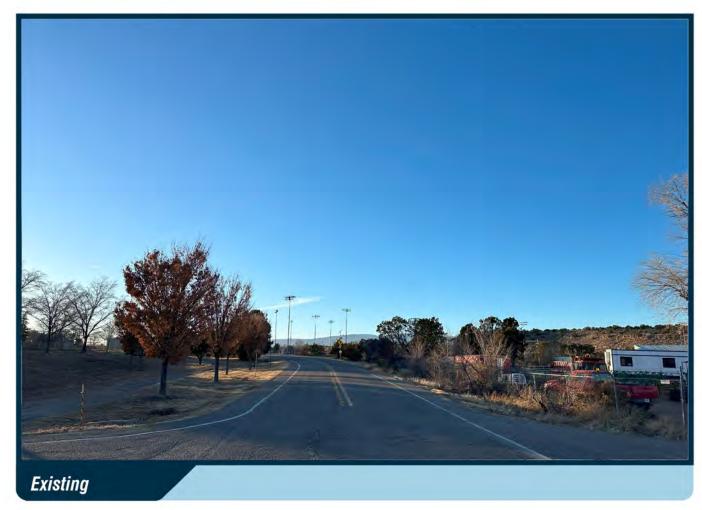



These depictions are for demonstrative purposes only.

They are to be used in addition to the engineering drawings for an accurate representation of the site

Applicant

Sun State Towers

1426 North Marvin Street, Suite 101 Gilbert, AZ 85233 Contact



01/03/2025

View 4

SUN STATE TOWERS

Address: 580 Overlook Rd. ~ Los Alamos, NM 87544 02/05/2025 View 1







These depictions are for demonstrative purposes only.

They are to be used in addition to the engineering drawings for an accurate representation of the site

Applicant

Sun State Towers


1426 North Marvin Street, Suite 101 Gilbert, AZ 85233



SUN STATE

Address: 580 Overlook Rd. ~ Los Alamos, NM 87544 02/05/2025 View 2



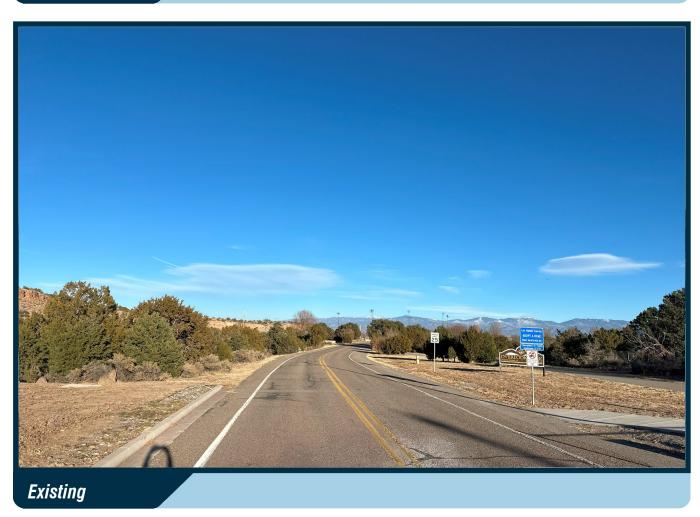



These depictions are for demonstrative purposes only.

They are to be used in addition to the engineering drawings for an accurate representation of the site

Applicant

Sun State Towers


1426 North Marvin Street, Suite 101 Gilbert, AZ 85233




SUN STATE

Address: 580 Overlook Rd. ~ Los Alamos, NM 87544 02/05/2025 View 3



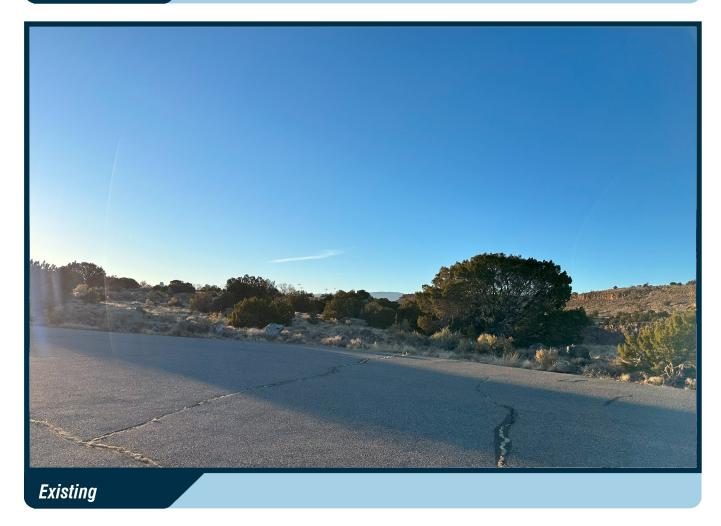

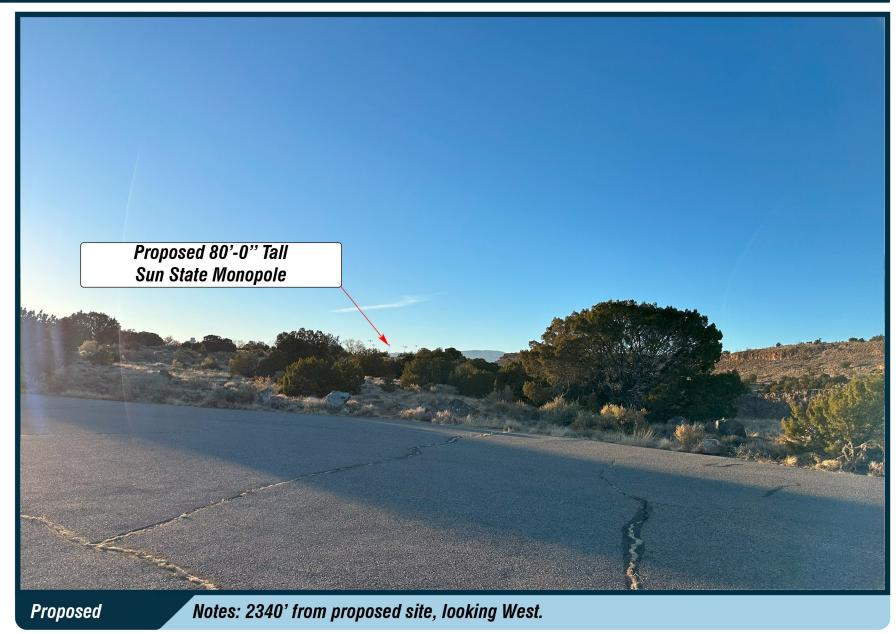

These depictions are for demonstrative purposes only.

They are to be used in addition to the engineering drawings for an accurate representation of the site

Applicant

Sun State Towers


1426 North Marvin Street, Suite 101 Gilbert, AZ 85233



SUN STATE

Address: 580 Overlook Rd. ~ Los Alamos, NM 87544 02/05/2025



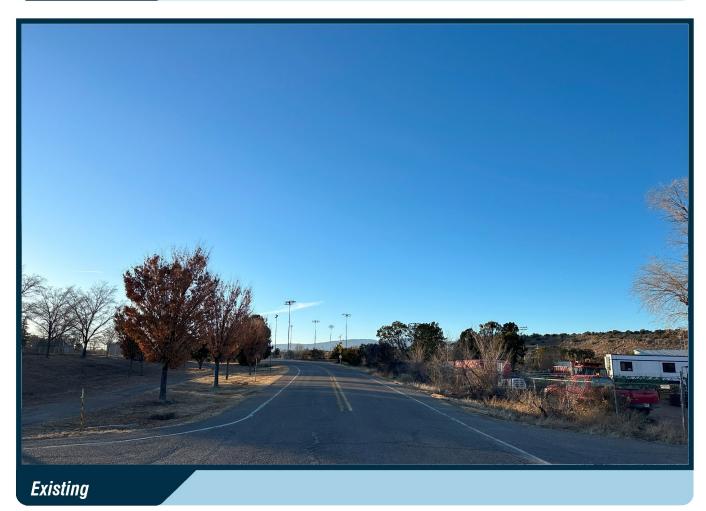



These depictions are for demonstrative purposes only.

They are to be used in addition to the engineering drawings for an accurate representation of the site

Applicant

Sun State Towers

1426 North Marvin Street, Suite 101 Gilbert, AZ 85233 Contact

View 4



WIRELESS NETWORK CONSULTING



Alternate Site & Height Analysis

- † Pinnacle requested a review of alternate site locations and alternative heights
- * Existing structures within 1000' of proposed
- * Analysis of lower heights compared to the proposed height
- † The sites modeled are as follows:
- † Alt 1 Approx 80' AGL Light Standard
 - 35.826512 Latitude
 - -106.188241 Longitude
- The alternate site analysis will consider the available height on the towers


Proposed and Alternates



ATTACHMENT A


2024

Focus Zone

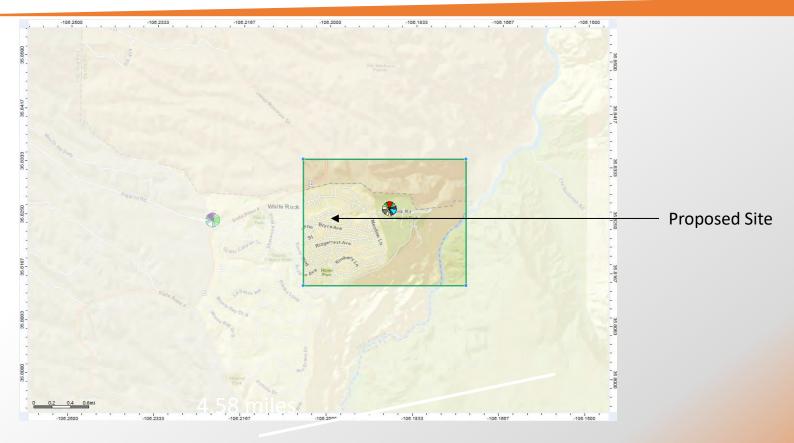

Focus Zone (Inside Green Line) is set up to analyze difference in coverage between the proposed and alternate sites requested by jurisdiction


RSRP Coverage - Low Band Proposed vs Alternate 1

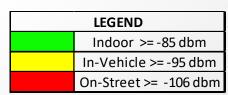

Surface (km2) % of Covered Area % Focus Zone

60.4

77.4

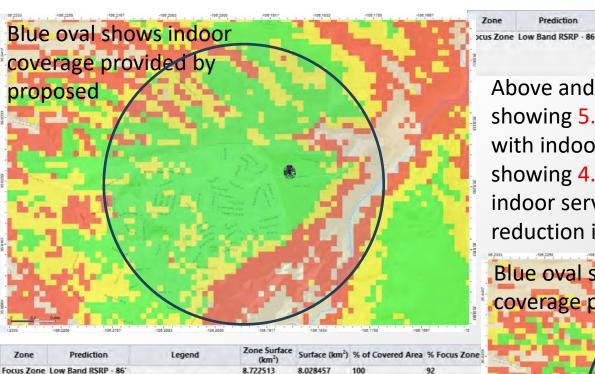

8.722513

RSRP Level (DL) (dBm) >=-85 RSRP Level (DL) (dBm) > = -95 RSRP Level (DL) (dBm) > = -106

- 3	RSRP Level (DL) (dBm) >=-106	7.954493	100	91.2
Above and	left picture show	ws Pro	posed dat	:a
showing 5.2	<mark>26</mark> square kilom	eters a	re covere	d
with indoor	service vs Alt 1	tower	data	
showing 4.4	49 square kilom	eters c	overed w	ith
indoor serv	ice. Approxima	tely a	15%	


8.722513

7.954493

Legend


RSRP Level (DL) (dBm) >=-85


RSRP Level (DL) (dBm) > = -95

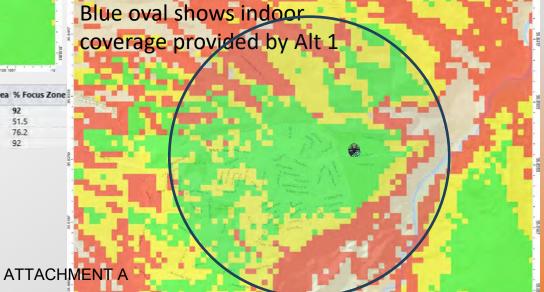

reduction in coverage for the objective.


RSRP Coverage - Mid Band Proposed vs Alternate 1

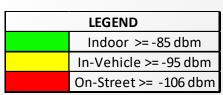

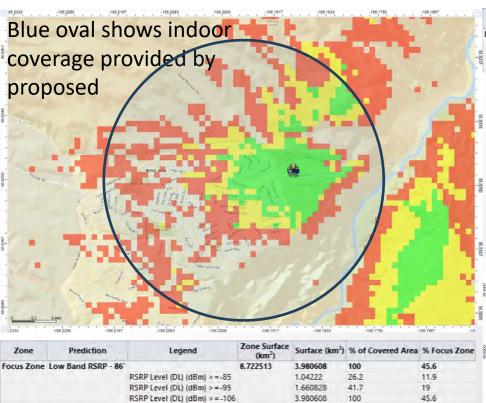

	Zone	Prediction	Legend	Zone Surface (km²)	Surface (km²)	% of Covered Area	% Focus Z
ı.	Focus Zone	Low Band RSRP - 86'		8.722513	4.895072	100	56.1
ı.			RSRP Level (DL) (dBm) > = -85		1.385144	28.3	15.9
-	S E		RSRP Level (DL) (dBm) > = -95		2.313056	47.3	26.5
ı.	9		RSRP Level (DI) (dBm) >=-106		4.895072	100	56.1

Above and left picture shows Proposed data showing 1.38 square kilometers are covered with indoor service vs T-Mobile tower data showing 1.04 square kilometers covered with indoor service. Approximately a 25% reduction in coverage for the objective.

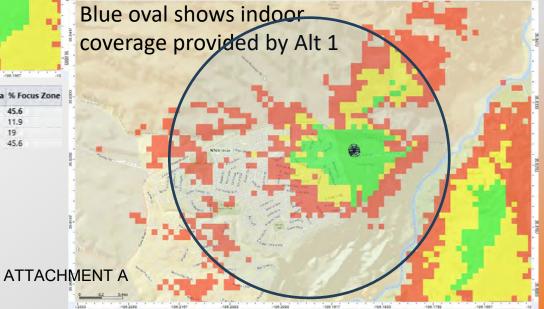

Analysis

- Reviewing the modeling the alternate site do not provide the same level of service of the proposed
- † Locating the antennas on lower heights on the alternate site would provide less coverage than the proposed
- † The alternate sites were analyzed against the primary objective

RSRP Coverage Low Band 76' vs 56' C/L (tower beight 80' vs 60' A




Surface (km2) % of Covered Area % Focus Zone

60.4

66.2

(tower height 80' vs 60' AGL)

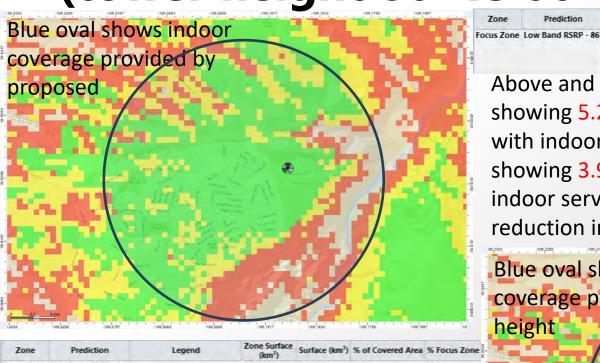

3,980608

6.542452

RSRP Level (DL) (dBm) > = -85

RSRP Level (DL) (dBm) >=-95


RSRP Level (DL) (dBm) >=-106

RSRP Level (DL)		7.954493	100	91.2
Above and left pic	cture shows	s Prop	osed da	ata
showing 5.26 squ	are kilomet	ers a	e cover	ed
with indoor service	ce vs lower	heigh	t data	
showing 3.98 squ	are kilomet	ers co	overed v	with
indoor service. A	pproximate	ely a <mark>2</mark>	5%	
reduction in cove	rage for the	e obje	ctive.	

RSRP Level (DL) (dBm) > = -85

RSRP Level (DL) (dBm) >=-95


8.722513

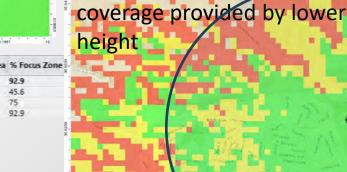

ATTACHMENT A

Blue oval shows indoor

RSRP Coverage Mid Band 76' vs 56' C/L (tower height 80' vs 60' AGL)

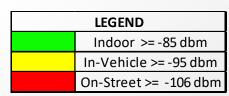


Surface (km2) % of Covered Area % Focus Zone

15.9

28.3

47.3

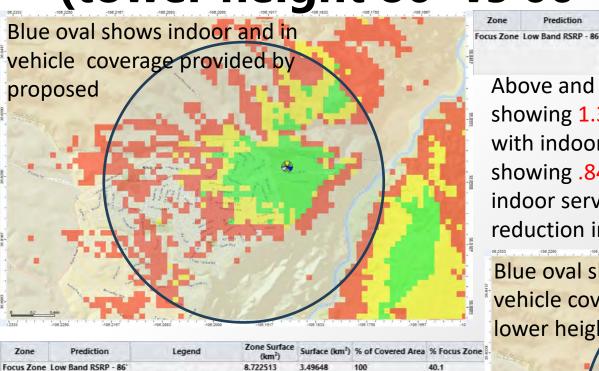

RSRP Level (DL) (dBm) > = -85

RSRP Level (DL) (dBm) >=-95

RSRP Level (DL) (dBm) > = -106

0.8405

1.37842

3,49648

24

39.4

15.8

RSRP Level (DL) (dBm) > = -106 4.895072 100 56.1
Above and left picture shows Proposed data
showing 1.38 square kilometers are covered
with indoor service vs lower height data
showing .84 square kilometers covered with
indoor service. Approximately a 40%
reduction in coverage for the objective.


RSRP Level (DL) (dBm) >=-85

RSRP Level (DL) (dBm) > = -95

8.722513

4.895072

1.385144

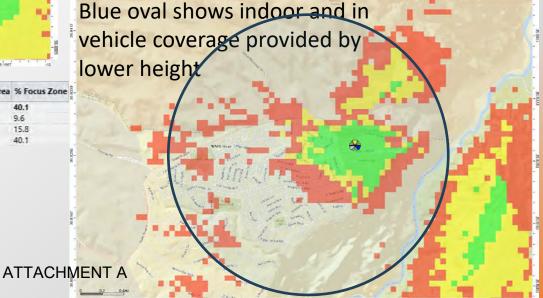

Analysis

- Reviewing the lower height shows that coverage will be impacted as well as the ability to have colocations on the proposed
- All (3) major carriers are lacking in quality service in the area, which means with the shorter height may mean more towers in the future
- † The lower heights were analyzed against the primary objective

Recommendation

- † Arbitrary height restrictions can cause decreases in coverage for tower sites
- † This impacts the number of towers in an area and what they provide coverage to
- It increases the chances for more towers as the towers are not able to accommodate more than 1 carrier
- Recommend approval of the proposed at the height requested for Verizon to provide high quality service to the area

Why here?

- Existing sites are overloaded with capacity (low throughput per user). A Cell Split is needed to increase the capacity in the area the proposed will offload existing Verizon sites that provide service
- Since this is a capacity need locating more antennas on the existing site 1.93 miles to the West that Verizon is already located on will not resolve the capacity issues in the area
- † A new site is needed to resolve the issues hence the proposed site.
- † Provide Indoor service to area around proposed
- Mobiles are reporting low quality connections for multiple carriers around the proposed

Zoom – proposed site



Verizon Sites

