# **EXHIBIT C**



# SUN STATE

# NM14-149 GRAND SLAM / NM4 OVERLOOK

APN: 104-01-0825-1495

580 OVERLOOK RD.

# LOS ALAMOS, NM 87544 LOS ALAMOS COUNTY

VICINITY MAP

DEPART ALBUQUERQUE INTERNATIONAL AIRPORT, HEAD SOUTH ON YALE BLVD SE, SLIGHT LEFT TO STAY ON YALE BLVD SE, MERGE ONTO SUNPORT BLVD. SLIGHT RIGHT TO STAY ON SUNPORT BLVD. KEEP LEF TO STAY ON SUNPORT BLVD. USE THE LEFT LANE TO MERGE ONTO SUNPORT LOOP SE, KEEP LEFT TO CONTINUE ON SUNPORT BLVD, USE THE RIGHT 2 LANES TO MERGE ONTO I-25 N VIA THE RAMP TO I-40. N/DOWNTOWN/SANTA FE. MERGE ONTO I-25 N. TAKE EXIT 276 FOR NM-599 S TOWARD MADRID. USE THE LEFT 2 LANES TO TURN LEFT ONTO NM-599 N. TAKE THE US-84 N/US-285 EXIT ON THE LEFT TOWARD ESPAÑOLA. MERGE ONTO US-285 N/US-84 W. TAKE THE NM-502 W/LOS ALAMOS EXIT. MERGE ONTO LOS ALAMOS HWY. CONTINUE ONTO NM-502. USE THE RIGHT 2 LANES TO TAKE THE NM-4 RAMP TO WHITE ROCK/BANDELIER NATL MON. CONTINUE ONTO NM-4 W. TURN LEFT ONTO ROVER BLVD. TURN LEFT ONTO MEADOW LN. TURN LEFT ONTO OVERLOOK RD. DESTINATION WILL BE ON THE LEFT.

# ROJECT DESCRIPTION

## SCOPE OF WORK

SHEET INDEX

Z-1

Z-2

Z-3

Z-4

Z-5

Z-6

Z-7

- INSTALL PROPOSED 80'-0" SUN STATE TOWERS GALVANIZED STEEL MONOPOLE
- INSTALL PROPOSED 20'-0"X30'-0" SPLIT FACE CMU WALL W/ SLOPPED SECURITY TOPPER
- INSTALL PROPOSED 4'-0"X12'-0" CONCRETE PAD
- INSTALL PROPOSED BATTERY CABINET
- INSTALL PROPOSED RF CABINET
- INSTALL PROPOSED GPS ANTENNA INSTALL (9) PROPOSED 4"Ø UNDERGROUND CONDUITS

PROJECT INFORMATION

OVERALL SETBACK PLAN

ENLARGED SITE PLAN AND ANTENNA PLAN

COMPOUND ENCLOSURE DETAIL

OVERALL SITE PLAN

EXISTING SITE PLAN

**ELEVATIONS** 

**ELEVATIONS** 

**ELEVATIONS** 

PROPOSED SITE PLAN

- INSTALL PROPOSED ELECTRICAL SERVICE
- INSTALL PROPOSED TELCO SERVICE
- INSTALL PROPOSED ANTENNA FRAME
- INSTALL [9] PROPOSED ANTENNAS INSTALL [9] PROPOSED REMOTE RADIO HEADS
- INSTALL [1] PROPOSED 12-PORT OVP
- INSTALL [2] PROPOSED HYBRIFLEX CABLES

CLIENT / TOWER OWNER: SUN STATE TOWERS 1426 N. MARVIN STREET #101 GII BERT A7 85233 CONTACT: CHAD WARD PHONE: [480] 664-9588

# PROPERTY OWNER:

LOS ALAMOS COUNTY 1000 CENTRAL AVE. LOS ALAMOS, NM 87544 PHONE: [505] 662-8333

#### CARRIER:

VERIZON WIRELESS 6955 W MORELOS PL CHANDLER, AZ 85226 CONTACT: JEFF DEWALT PHONE: [505] 332-6007

PINNACLE CONSULTING, INC. 1426 N. MARVIN STREET #101 GILBERT, AZ 85233

## **ENGINEERING FIRM:**

PINNACLE CONSULTING, INC. 1426 N. MARVIN STREET #101 GILBERT, AZ 85233 ENGINEER: KYLE FORTIN, PE PHONE: [623] 217-4235

### SITE ACQUISITION:

CONTACT: MICHELLE JOHNSON PHONE: (480) 664-9588 ext. 230

#### **GENERAL NOTES**

- THIS WIRELESS TELECOMMUNICATIONS FACILITY WILL MEET THE HEALTH AND SAFETY STANDARDS FOR ELECTROMAGNETIC FIELD EMISSIONS AS ESTABLISHED BY THE FEDERAL COMMUNICATIONS COMMISSION OR ANY SUCCESSOR THEREOF, AND ANY OTHER FEDERAL OR STATE AGENCY.
- 2. THIS WIRELESS TELECOMMUNICATIONS FACILITY WILL MEET THE REGULATIONS OF THE FEDERAL COMMUNICATIONS COMMISSION REGARDING PHYSICAL AND ELECTROMAGNETIC INTERFERENCE.
- 3. LIGHTING OR SIGNS WILL BE PROVIDED ONLY AS REQUIRED BY FEDERAL OR STATE AGENCIES
- 4 DEVELOPMENT AND CONSTRUCTION OF THIS PROJECT WILL COMPLY WITH ALL APPLICABLE CODES AND ORDINANCES.
- 5. EXISTING PARKING IS NOT AFFECTED BY THIS PROJECT.
- 6. THIS PROJECT DOES NOT INCLUDE WATER OR SEWER.
- 7. THIS PROJECT INCLUDES C-BAND INSTALLATION
- 8. NO ABANDONMENT OF A SMALL WIRELESS FACILITY SHALL BE PERMITTED. ALL SMALL WIRELESS FACILITIES NOT IN SERVICE SHALL BE PHYSICALLY MAINTAINED AS IF IN SERVICE FOR THE PROTECTION AND SAFETY OF THE PUBLIC.

# OVERLOOK RD.

## COORDINATES

PARCEL #:

**NEW LEASE AREA:** 

JURISDICTION:

USE:

**TOWER COORDINATES:** 

TOWER LATITUDE 35.826752° 35° 49' 36.31" N [NAD83] TOWER LONGITUDE -106.188301° -106° 11' 17.89" W [NAD83] TOWER GROUND ELEVATION

104-01-0825-1495

LOS ALAMOS COUNTY

ALL BUILDING CODES LISTED ABOVE

SHALL INCLUDE AMENDMENTS BY THE

2200 SQ. FT

**GOVERNING CODES:** 2021 IBC, 2021 NMBC, 2015 NFPA 1

2020 NMEC

GOVERNING JURISDICTION

UNMANNED COMMUNICATIONS

FIBER MMP (MEET ME POINT) COORDINATES:

MMP LATITUDE 35.826074° 35° 49' 33.87" N [NAD83] MMP LONGITUDE -106.188313° -106° 11' 17.93" W [NAD83]

APPROVALS	
[RF]:	DATE:
[CONST.]:	DATE:
[RE]:	DATE:
LANDLORD:	DATE:



GII BERT AZ 85233

2600 W. GERONIMO PL., CHANDLER, AZ 85224 PHONE: (480) 777-4360 FAX: (480) 777-4391




A&F CONSULTING FIRM & SITE ACQUISITION

1426 NORTH MARVIN STREET # 101 GILBERT, AZ 85233

PROJECT NO:	NM14-149 GRAND SLAM
DRAWN BY:	cs
CHECKED BY:	KF

REV	DATE	DESCRIPTION	BY
4	02/18/25	FINAL ZONING	cs
5	03/12/25	FINAL ZONING	CS

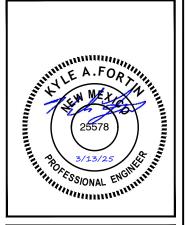



NM14-149 GRAND SLAM NM4 OVERLOOK

> 580 OVERLOOK RD LOS ALAMOS, NM 87544 LOS ALAMOS COUNTY

> > SHEET TITLE

PROJECT INFORMATION

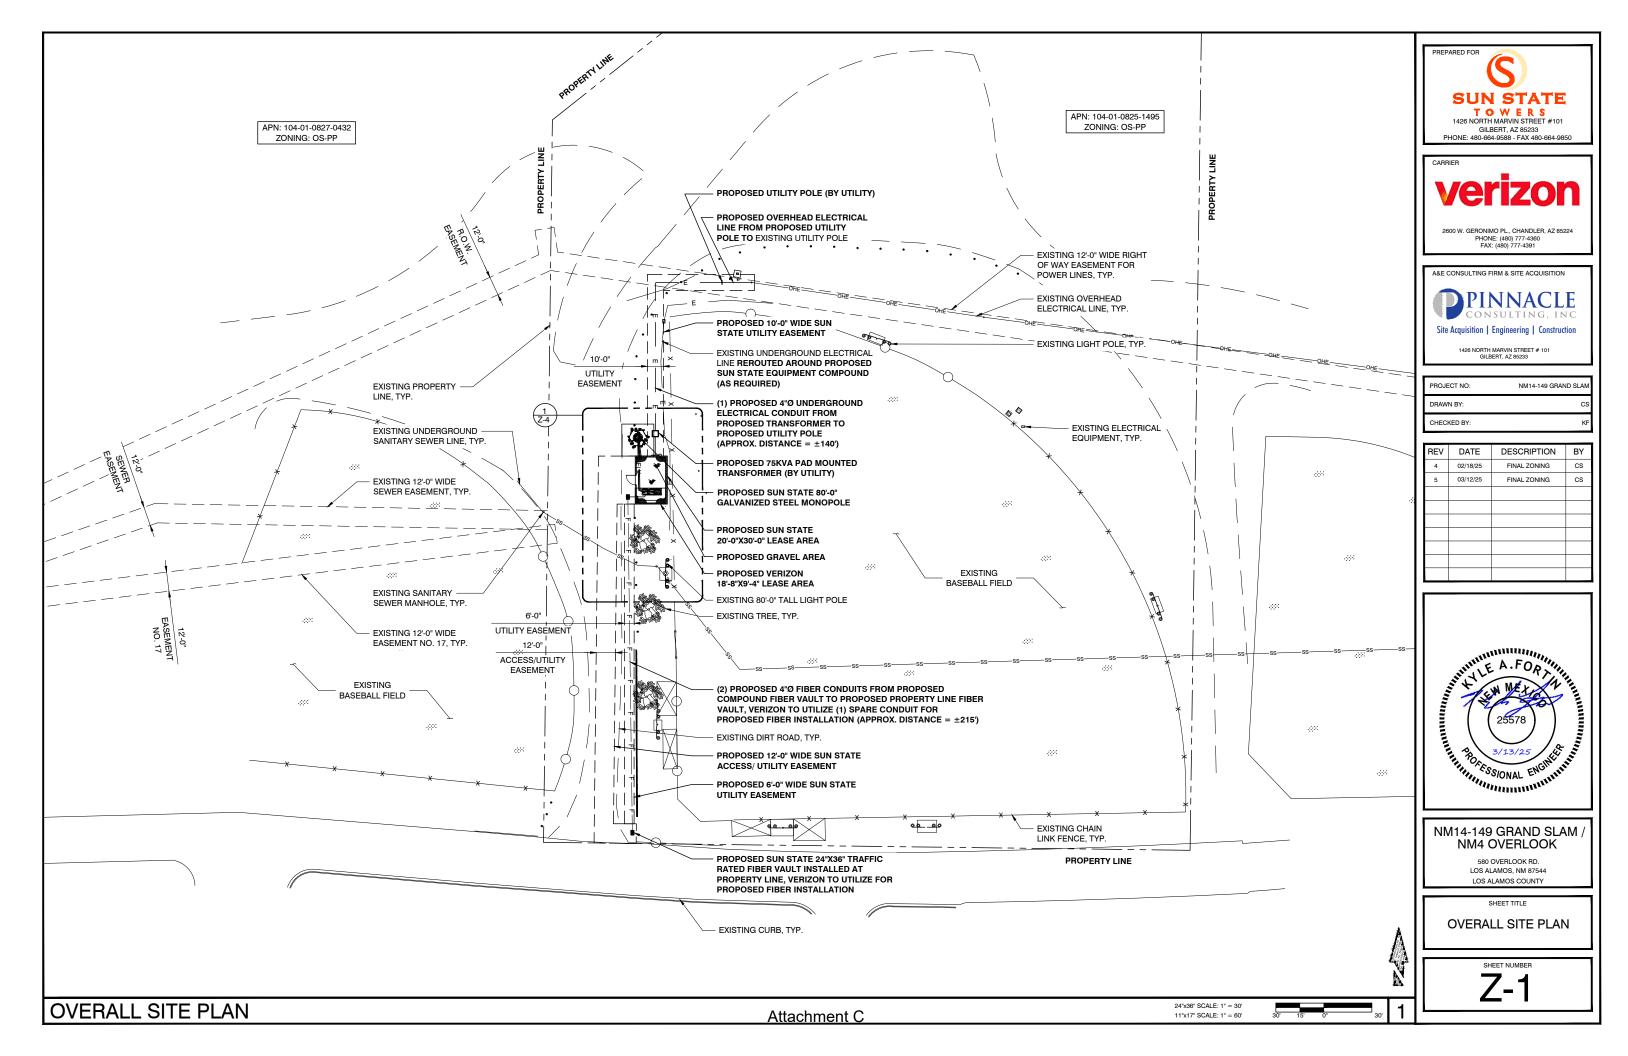

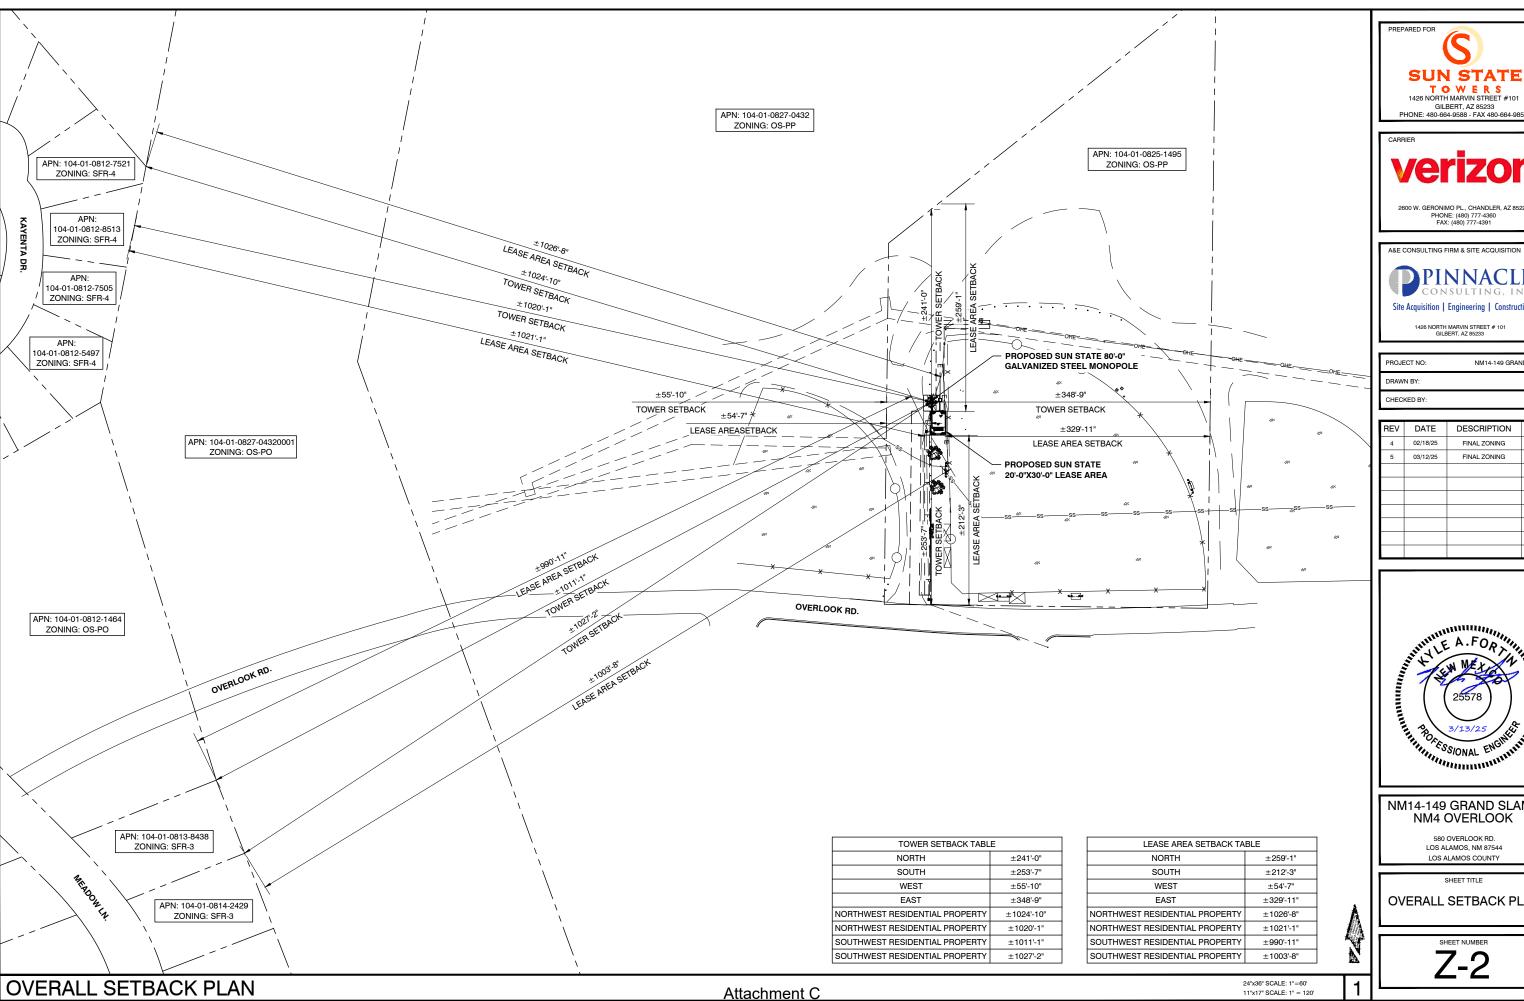

PREPARED FOR **SUN STATE** TOWERS
1426 NORTH MARVIN STREET #101


GILBERT, AZ 85233 PHONE: 480-664-9588 - FAX 480-664-9850

2600 W. GERONIMO PL., CHANDLER, AZ 85224 PHONE: (480) 777-4360 FAX: (480) 777-4391

PINNACLE Site Acquisition | Engineering | Construction

PROJECT NO: NM14-149 GRAND SLAN DRAWN BY: CHECKED BY:

REV	DATE	DESCRIPTION	BY
4	02/18/25	FINAL ZONING	CS
5	03/12/25	FINAL ZONING	CS

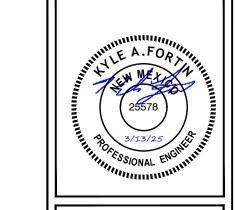


# NM14-149 GRAND SLAM NM4 OVERLOOK

580 OVERLOOK RD. LOS ALAMOS, NM 87544 LOS ALAMOS COUNTY

SHEET TITLE

**OVERALL SETBACK PLAN** 


**Z-2** 

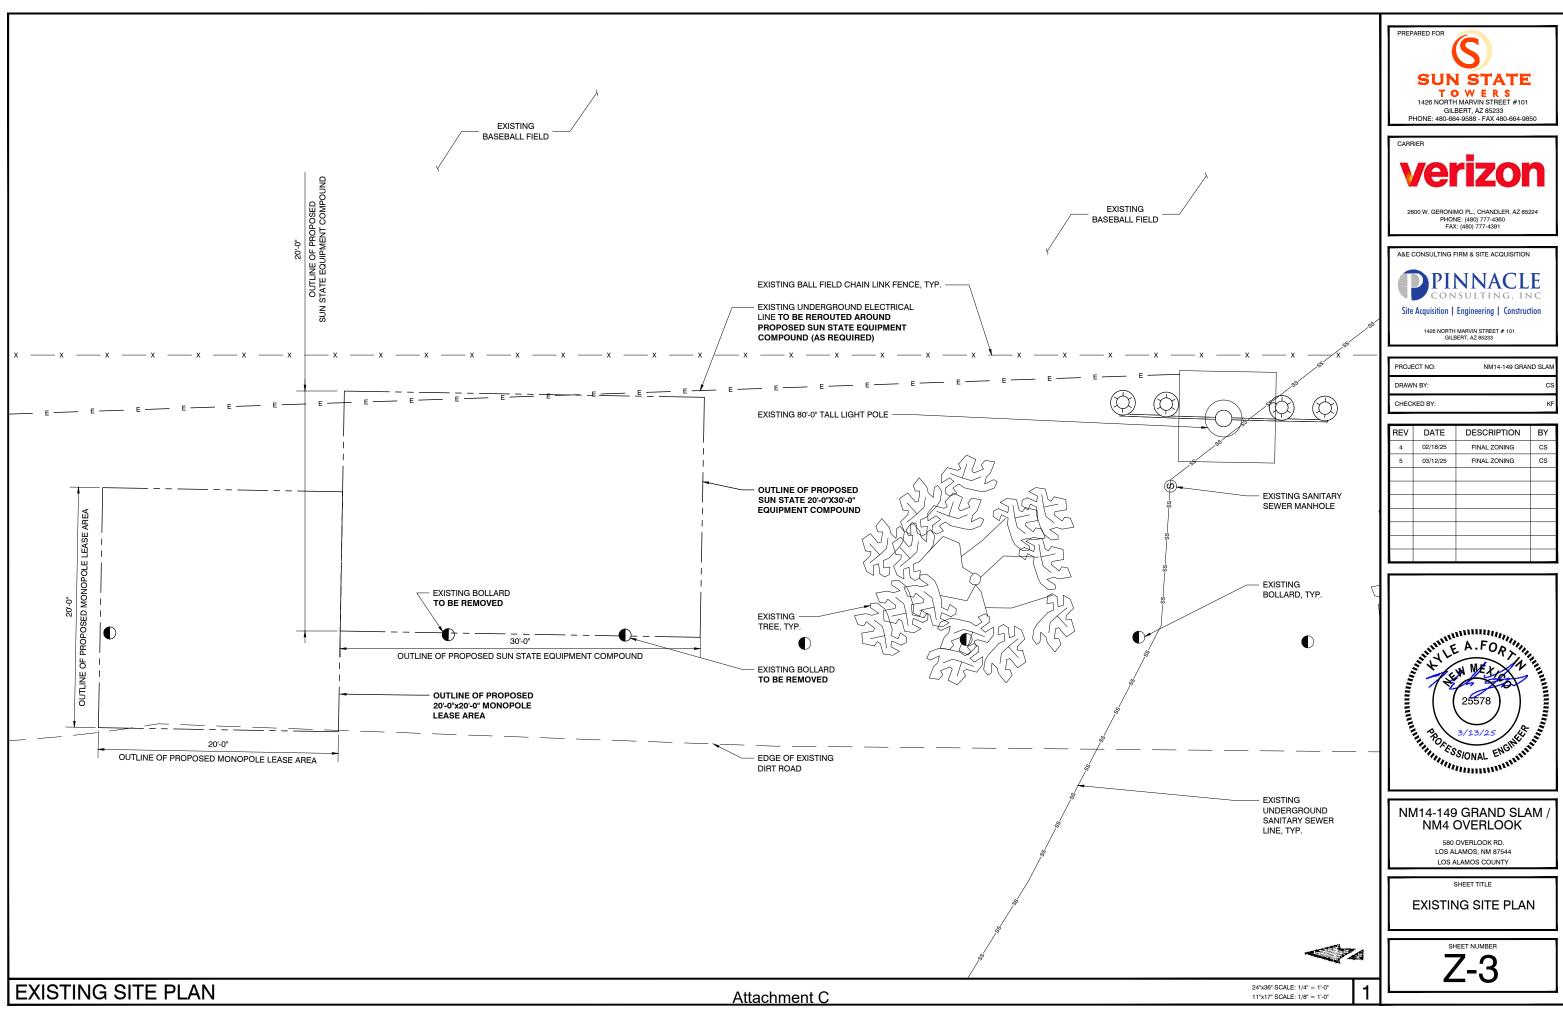





NM14-149 GRAND SLAN

	REV	DATE	DESCRIPTION	BY
	4	02/18/25	FINAL ZONING	cs
	5	03/12/25	FINAL ZONING	cs
1				

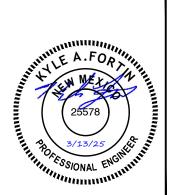

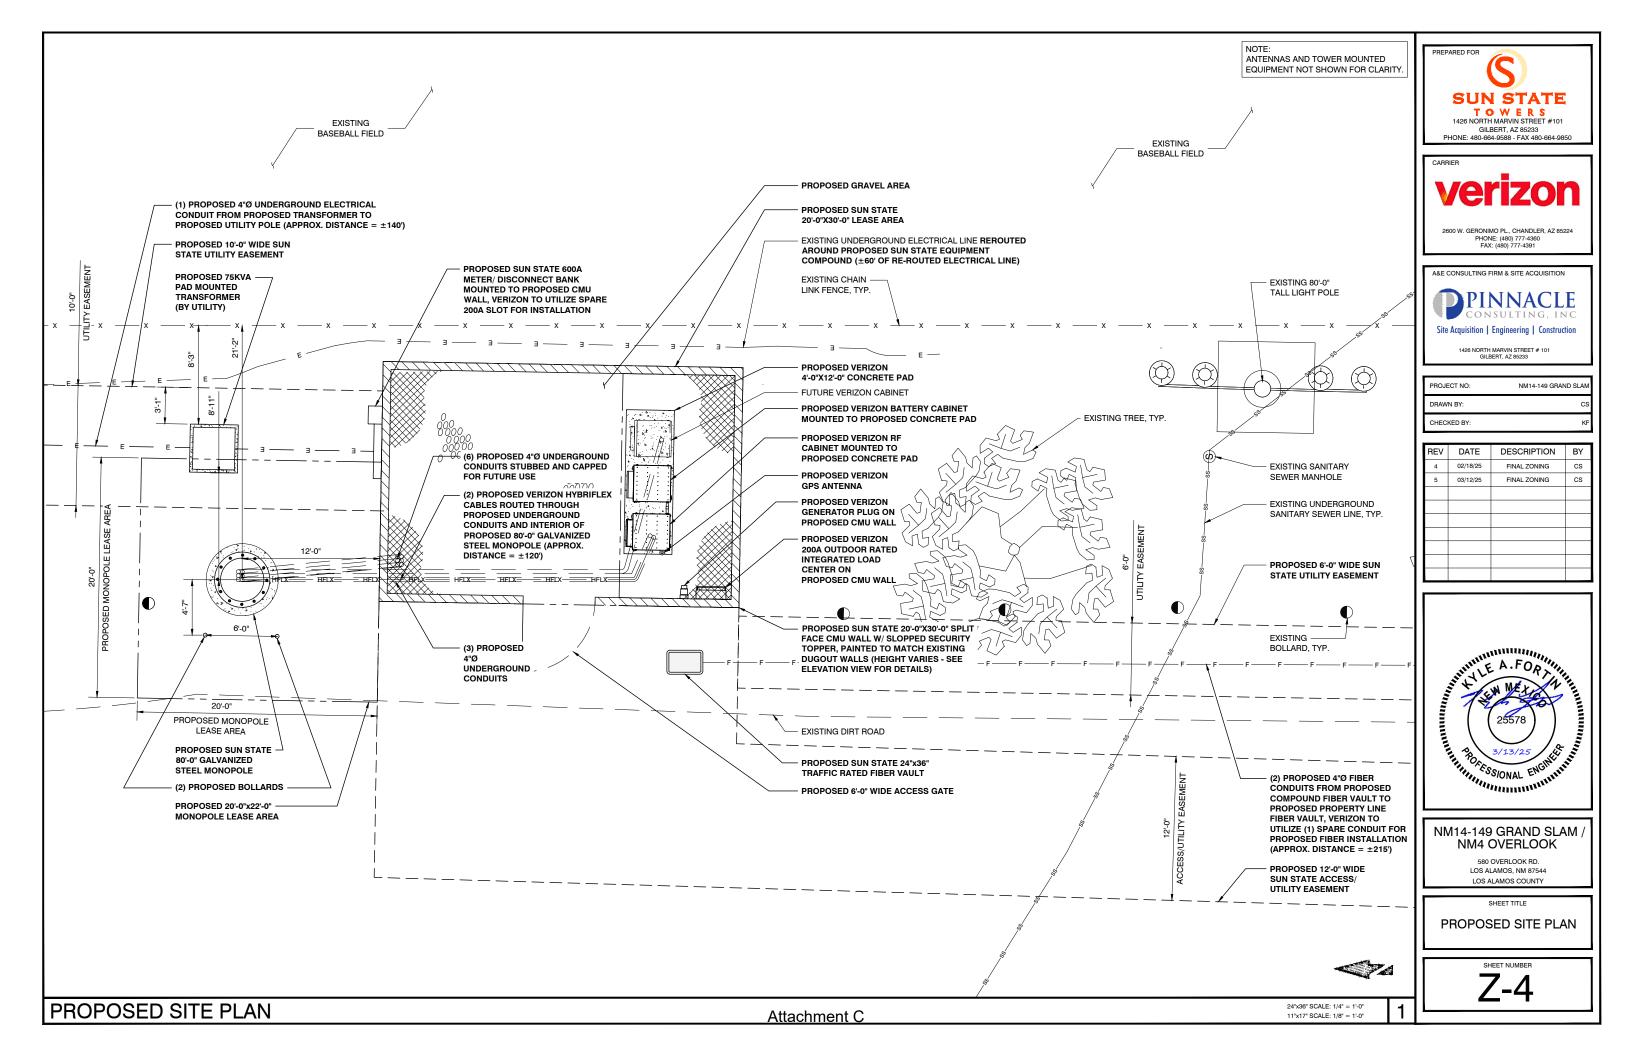

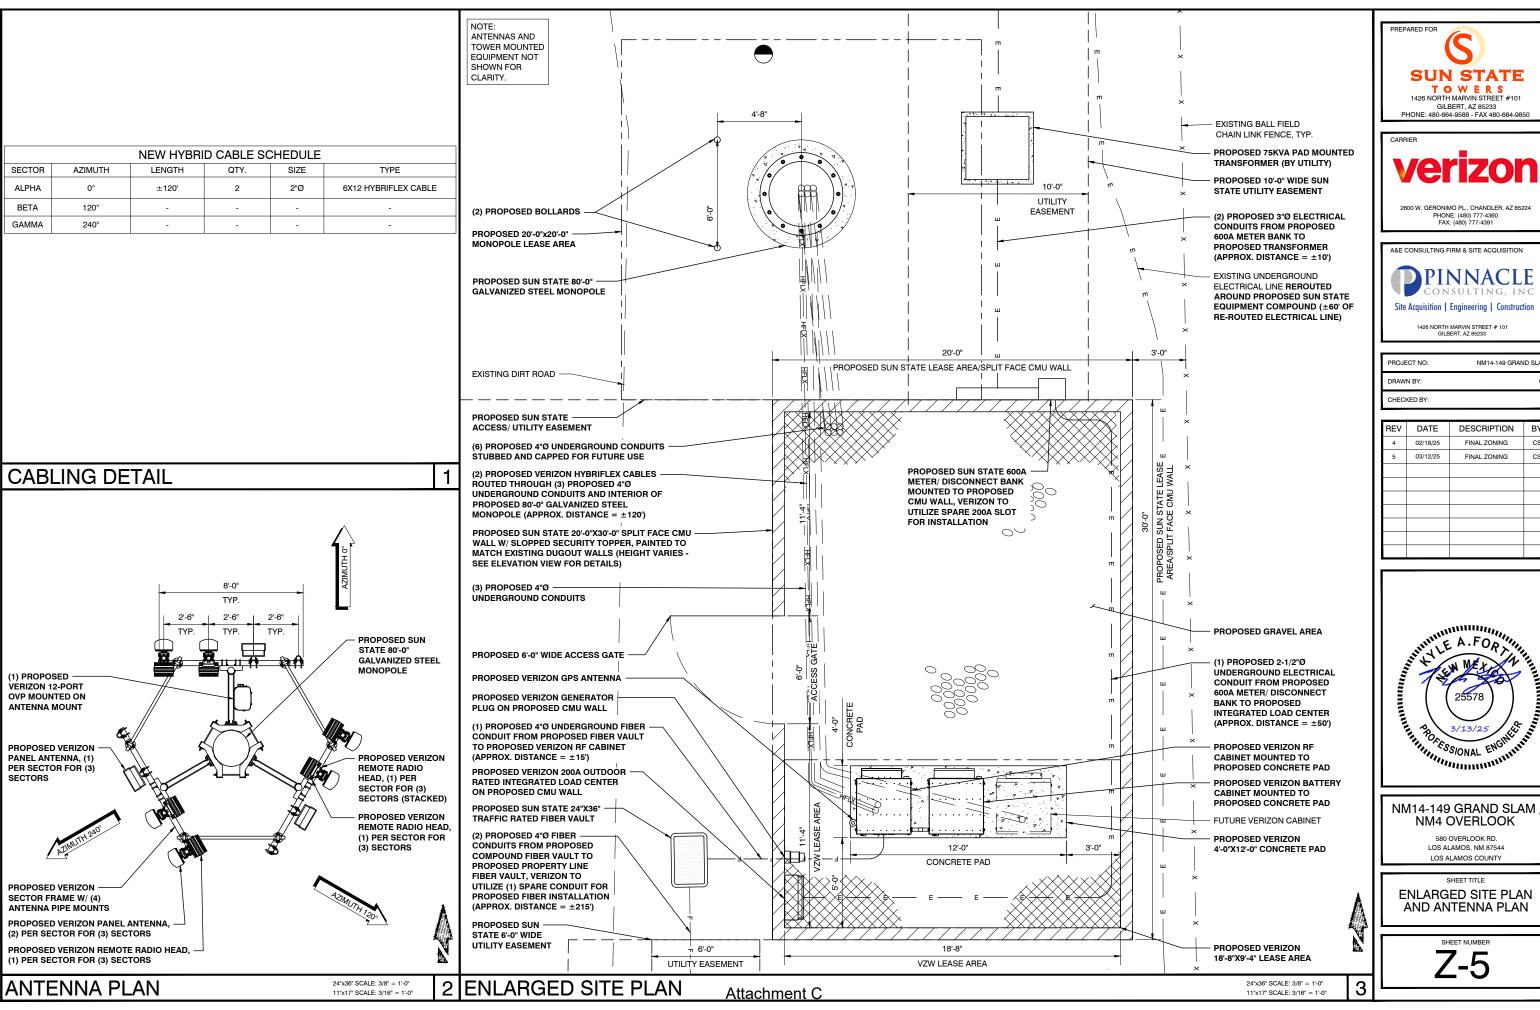

TOWERS
1426 NORTH MARVIN STREET #101

2600 W. GERONIMO PL., CHANDLER, AZ 85224

PINNACLE


NM14-149 GRAND SLA

REV	DATE	DESCRIPTION	BY
4	02/18/25	FINAL ZONING	CS
5	03/12/25	FINAL ZONING	CS



NM14-149 GRAND SLAM NM4 OVERLOOK

**ENLARGED SITE PLAN** AND ANTENNA PLAN

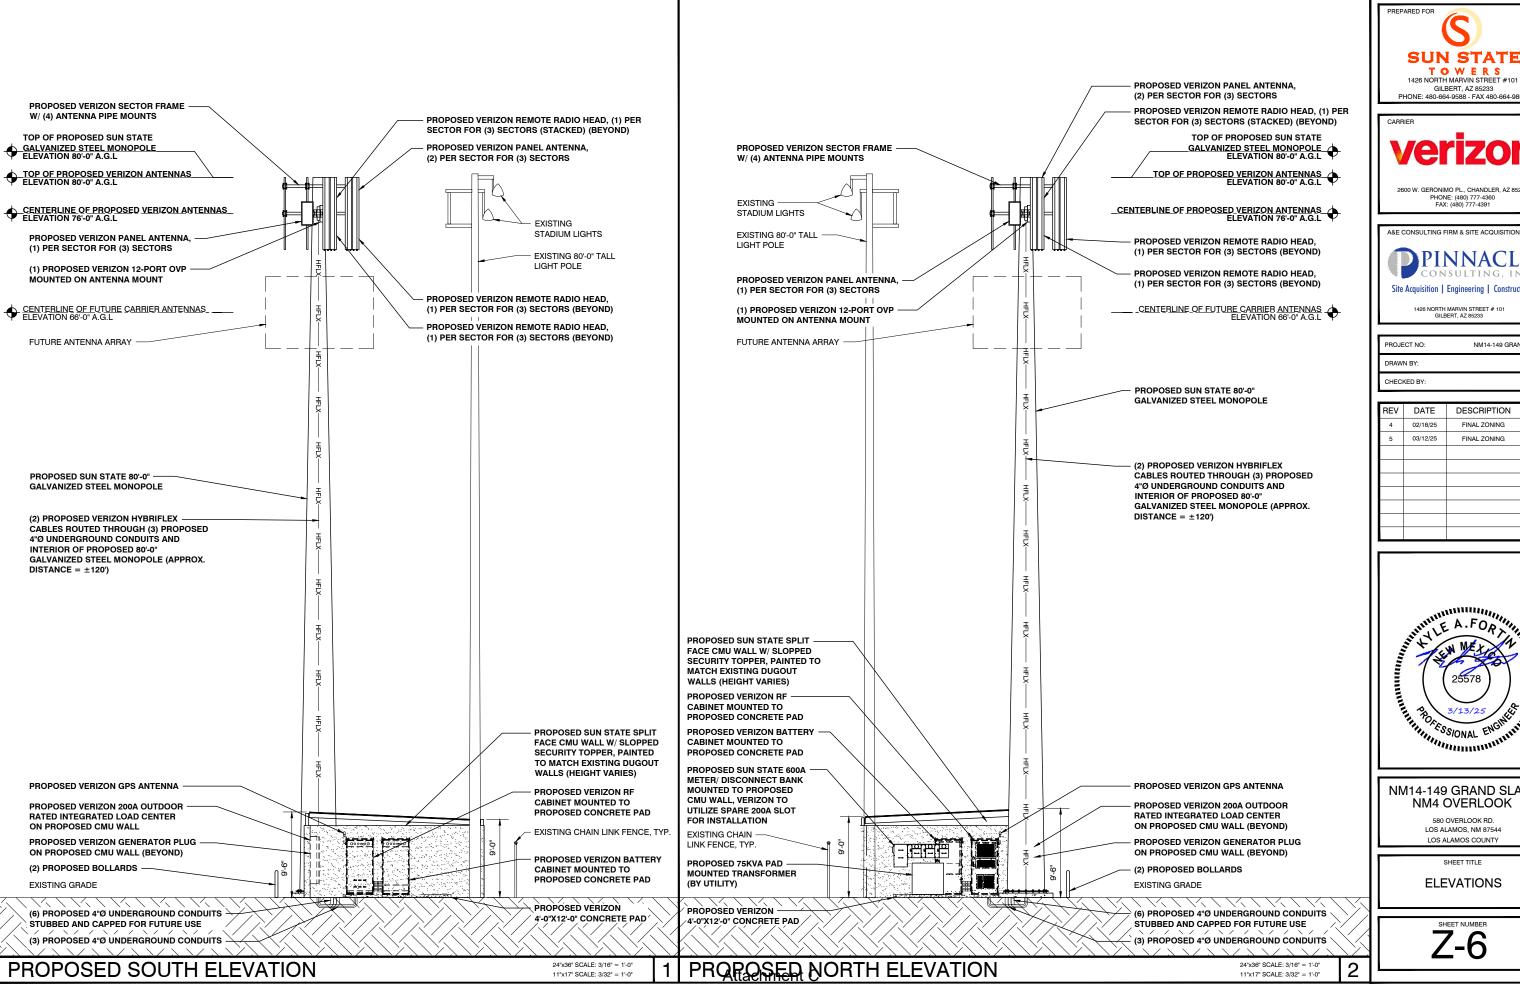



GILBERT, AZ 85233 PHONE: 480-664-9588 - FAX 480-664-9850

erizon


2600 W. GERONIMO PL., CHANDLER, AZ 85224 PHONE: (480) 777-4360 FAX: (480) 777-4391

PINNACLE Site Acquisition | Engineering | Construction

1426 NORTH MARVIN STREET # 101 GILBERT, AZ 85233

NM14-149 GRAND SLA

REV	DATE	DESCRIPTION	BY
4	02/18/25	FINAL ZONING	cs
5	03/12/25	FINAL ZONING	CS

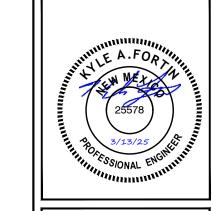


NM14-149 GRAND SLAM / NM4 OVERLOOK

> 580 OVERLOOK RD LOS ALAMOS, NM 87544 LOS ALAMOS COUNTY

> > SHEET TITLE

**ELEVATIONS** 

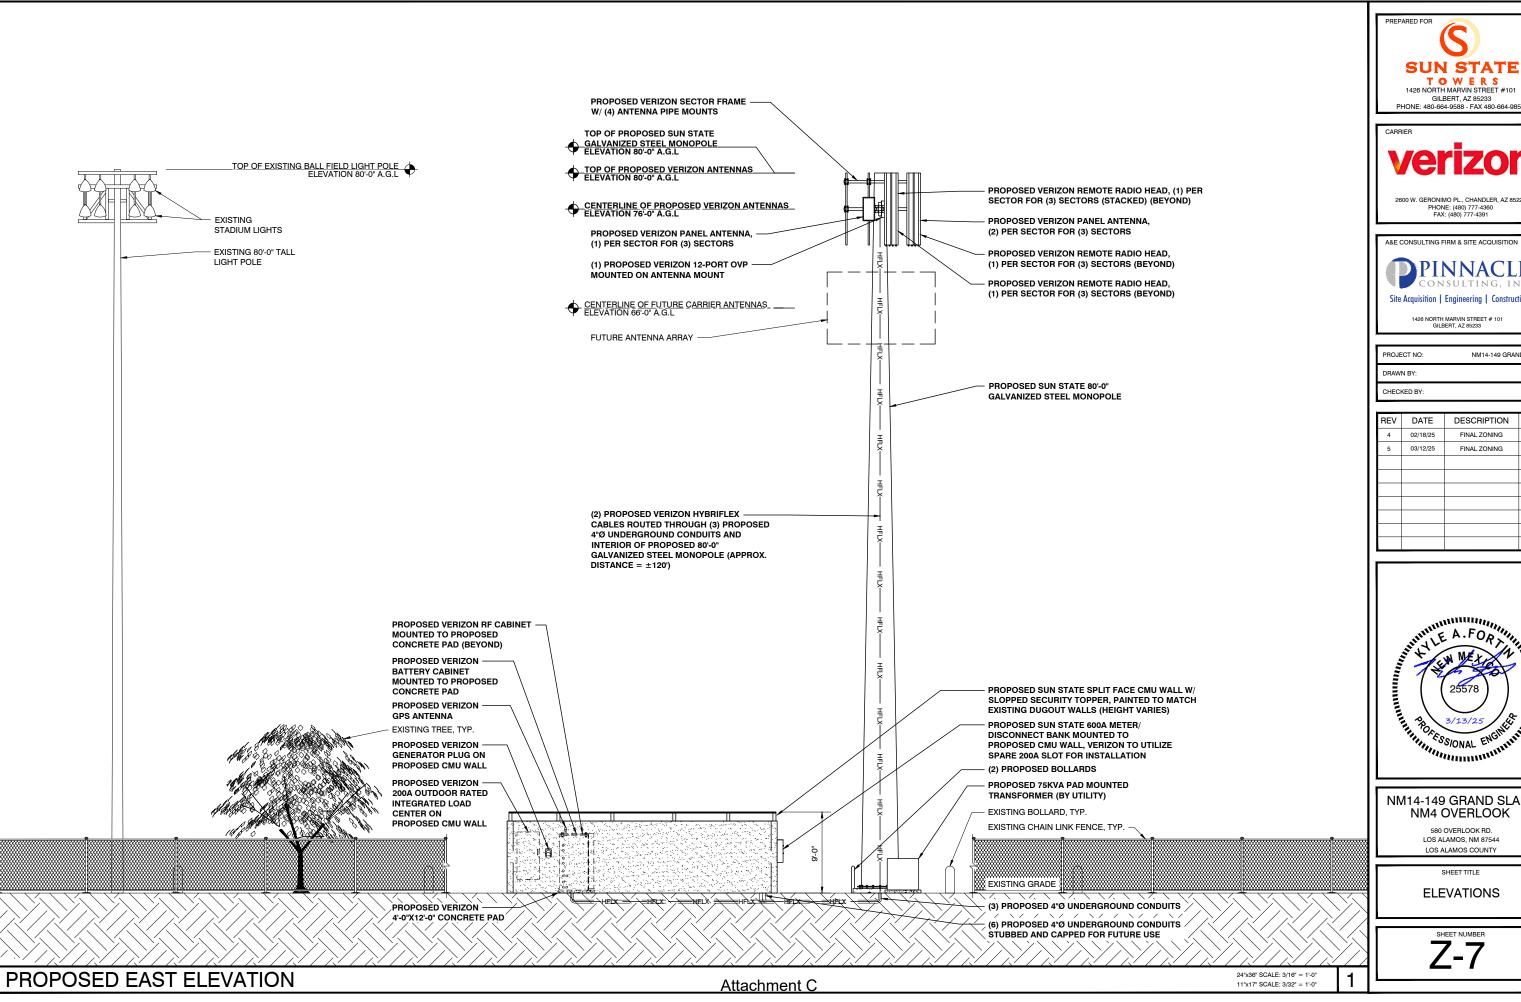




GILBERT, AZ 85233 PHONE: 480-664-9588 - FAX 480-664-9850

2600 W. GERONIMO PL., CHANDLER, AZ 85224 PHONE: (480) 777-4360 FAX: (480) 777-4391

PINNACLE

PROJECT NO: NM14-149 GRAND SLAN DRAWN BY:

REV	DATE	DESCRIPTION	BY
4	02/18/25	FINAL ZONING	CS
5	03/12/25	FINAL ZONING	cs

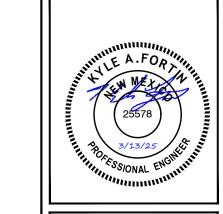


NM14-149 GRAND SLAM / NM4 OVERLOOK

> 580 OVERLOOK RD. LOS ALAMOS, NM 87544 LOS ALAMOS COUNTY

> > SHEET TITLE

**ELEVATIONS** 

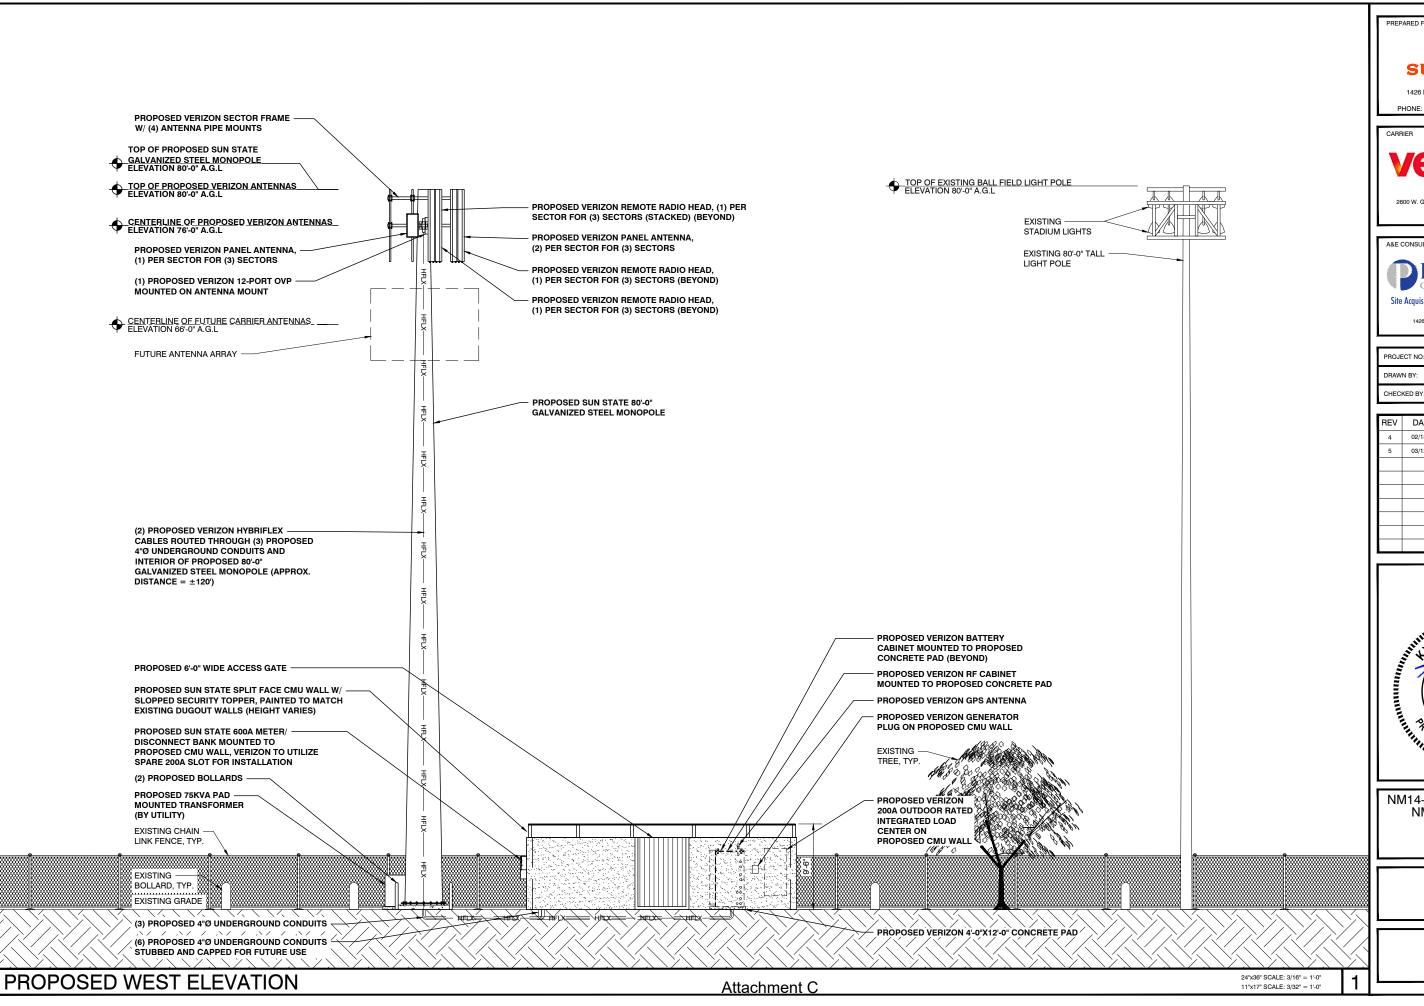



GILBERT, AZ 85233 PHONE: 480-664-9588 - FAX 480-664-9850

2600 W. GERONIMO PL., CHANDLER, AZ 85224 PHONE: (480) 777-4360 FAX: (480) 777-4391


A&E CONSULTING FIRM & SITE ACQUISITION



1426 NORTH MARVIN STREET # 101 GILBERT, AZ 85233

PROJECT NO: NM14-149 GRAND SLAN DRAWN BY:

REV	DATE	DESCRIPTION	BY
4	02/18/25	FINAL ZONING	CS
5	03/12/25	FINAL ZONING	CS

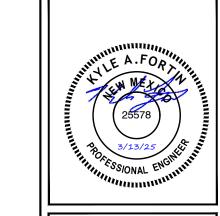

# NM14-149 GRAND SLAM/ NM4 OVERLOOK

580 OVERLOOK RD. LOS ALAMOS, NM 87544 LOS ALAMOS COUNTY

SHEET TITLE

**ELEVATIONS** 

# MASONRY NOTES:

#### **MASONRY WALL GENERAL NOTES**

2021 NEW MEXICO COMMERCIAL BUILDING CODE

104 MPH ULTIMATE DESIGN WIND SPEED (RISK CATEGORY II) EXPOSURE C

#### SEISMIC:

RISK CATEGORY II SITE CLASS: C SEISMIC DESIGN CATEGORY C Ss = 0.495S1 = 0.161

#### GEOTECHNICAL

FOUNDATION DESIGN IN ACCORDANCE WITH RECOMMENDATIONS PROVIDED IN GEOTECHNICAL REPORT NO.: 2022130.36

BY GDP GROUP

DATED JANUARY 24, 2023

ALLOWABLE BEARING PRESSURE = 3000PSF

AT 2'-6" BELOW LOWEST ADJACENT FINISHED GRADE. REFER TO SOILS REPORT FOR ADDITIONAL INFORMATION.

#### CONCRETE:

CONSTRUCTION SHALL BE IN ACCORDANCE WITH ACI 318. CONCRETE SHALL HAVE A MINIMUM COMPRESSIVE STRENGTH OF 2500 PSI AT 28 DAYS. VIBRATE REINFORCED CONCRETE DURING PLACEMENT.

DEFORMED REINFORCING BARS SHALL CONFORM TO ASTM A615, GRADE 60. ALI REINFORCING SHALL BE SECURELY TIED TO PREVENT MOVEMENT WHILE PLACING CONCRETE. WELDING OF REINFORCING IS NOT ALLOWED. LAP REINFORCING 48 BAR DIAMETERS (30" FOR #5, 24" FOR #4). BEND REINFORCING OR PROVIDE CORNER BARS WHERE FOOTING CHANGES DIRECTION.

MINIMUM CONCRETE COVER FOR REINFORCING STEEL CAST IN CONCRETE (UNO):

CAST AGAINST EARTH:

PERMANENTLY EXPOSED TO EARTH OR WEATHER: 1 1/2" (#5 AND SMALLER) 2" (#6 AND LARGER)

#### MASONRY:

CONCRETE MASONRY UNITS (CMU) SHALL CONFORM TO ASTM C90, LOAD BEARING WITH A MINIMUM COMPRESSIVE STRENGTH OF 1900 PSI (NET AREA).

MORTAR SHALL CONFORM TO ASTM C-270, TYPE S.

FILL ALL REINFORCED CELLS WITH 2000 PSI GROUT OR GROUT CONFORMING TO ASTM C476. MAXIMUM GROUT POUR IS 5'-4" WITHOUT CLEANOUTS. MECHANICALLY CONSOLIDATE GROUT AFTER PLACEMENT AND RECONSOLIDATE AFTER APPROXIMATELY 5 MINUTES. SOLID GROUT ALL CELLS BELOW FINISHED

PROVIDE MASONRY CONTROL JOINTS AT 24' O.C. MAXIMUM WITH A MINIMUM WALL SEGMENT LENGTH OF 8'.

DEFORMED BAR REINFORCING SHALL CONFORM TO ASTM A615, GRADE 60. LAP 48 BAR DIAMETERS (30" FOR #5, 24" FOR #4).

VERTICAL REINFORCING SHALL BE #5, CENTERED IN CELL AT SPACING NOTED ON DRAWING OR AT 48" O.C. MINIMUM. PROVIDE VERTICAL BARS AT ALL WALL ENDS CORNERS, INTERSECTIONS AND EACH SIDE OF CONTROL JOINTS. ALL VERTICAL BARS SHALL BE DOWELED INTO CONCRETE FOOTING WITH A MINIMUM 30"

HORIZONTALLY REINFORCE WALLS WITH (1) #5 IN 8" DEEP SOLID GROUTED BOND BEAM AT TOP OF WALL. PROVIDE BENT CORNER BARS TO MATCH BOND BEAM REINFORCING AT ALL CORNERS. PROVIDE 9 GAUGE (W1.7) GALVANIZED LADDER TYPE HORIZONTAL JOINT REINFORCING CONFORMING TO ASTM A951 AT 16" O.C. VERTICALLY MAXIMUM.


#### SPECIAL INSPECTIONS:

SPECIAL INSPECTIONS REQUIRED PER IBC CHAPTER 17 FOR THE FOLLOWING ITEMS CONCRETE:

> • PERIODIC INSPECTION TO VERIFY FOUNDATION SIZE AND REINFORCING SIZE & PLACEMENT

#### MASONRY

- PERIODIC INSPECTION TO VERIFY CMU CONSTRUCTION AND REINFORCING SIZE & PLACEMENT
- CONTINUOUS INSPECTION DURING PLACEMENT OF GROUT

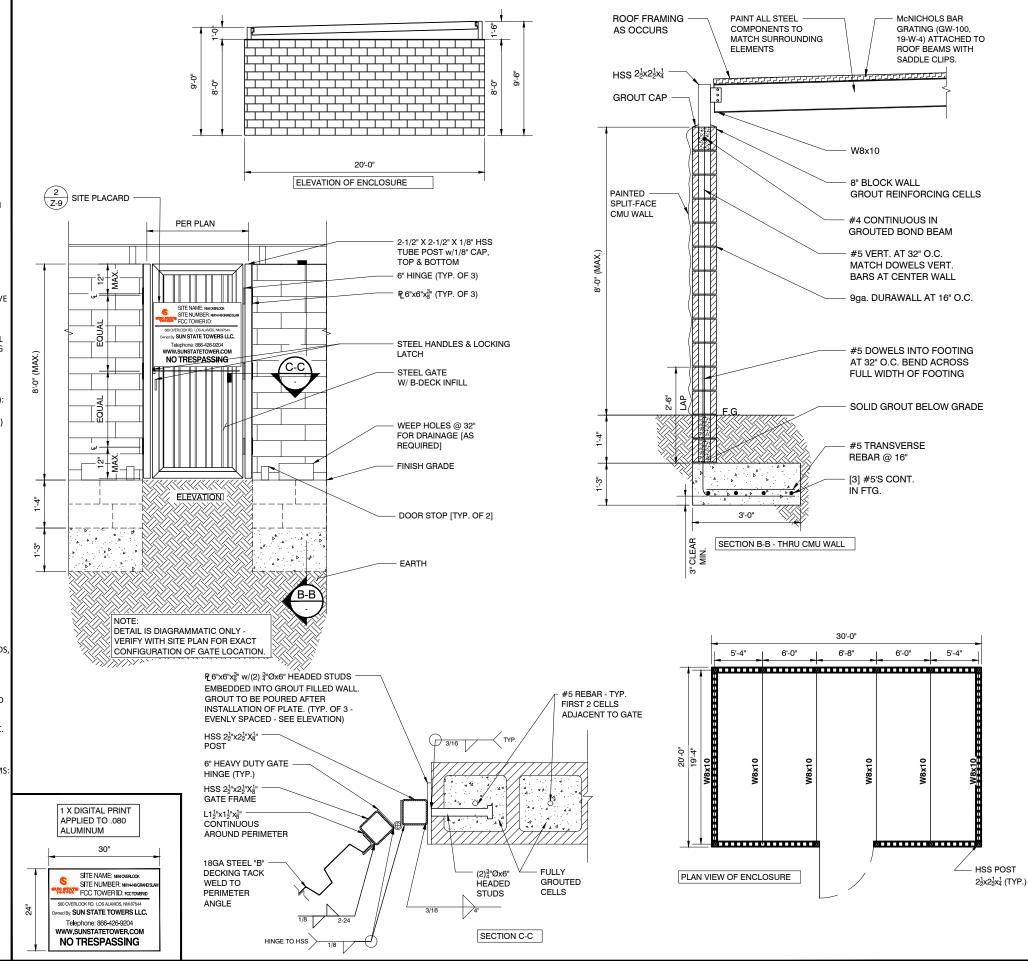




GII BERT AZ 85233 PHONE: 480-664-9588 - FAX 480-664-9850

2600 W. GERONIMO PL., CHANDLER, AZ 85224 PHONE: (480) 777-4360 FAX: (480) 777-4391

A&F CONSULTING FIRM & SITE ACQUISITION PINNACLE Site Acquisition | Engineering | Construction

PROJECT NO NM14-149 GRAND SLA DRAWN BY: CHECKED BY

REV	DATE	DESCRIPTION	BY
4	02/18/25	FINAL ZONING	cs
5	03/12/25	FINAL ZONING	cs

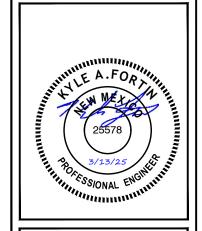

NM14-149 GRAND SLAM NM4 OVERLOOK

> 580 OVERLOOK RD LOS ALAMOS, NM 87544 LOS ALAMOS COUNTY

SHEET TITLE COMPOUND ENCLOSURE **DETAIL** 

**Z-9** 

SCALE: NTS 3

SIGN DETAIL 2 COMPOUND ENGLIPSIVE DETAIL