

ABIQUIU HYDROELECTRIC PLANT OFFICE **EXPANSION**


LOS ALAMOS COUNTY - NEW MEXICO

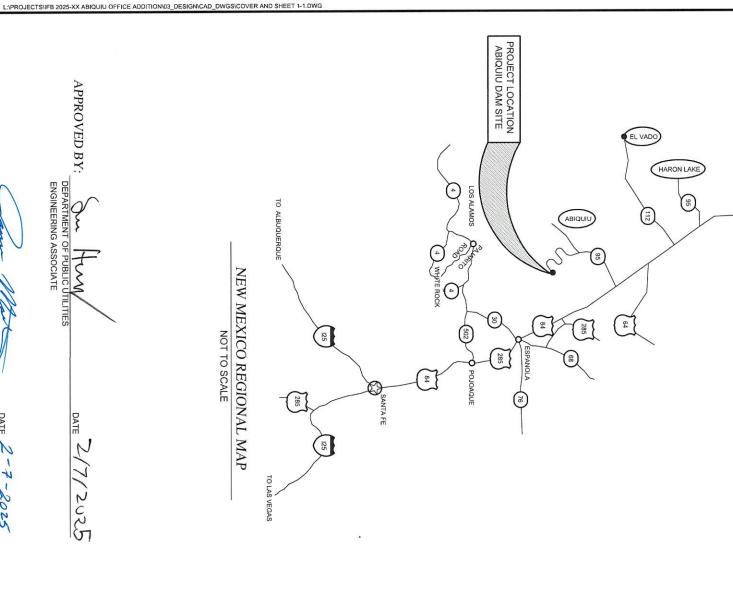

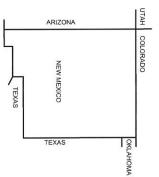



MEXICO

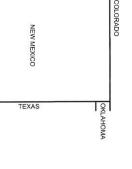





TITLE SHEET

- GENERAL NOTES
- EXISTING REFLECTED FLOOR PLAN

2

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- PROPOSED REFLECTED FLOOR PLAN
- ROOFING PLAN
- **ELEVATIONS**

5

CONCRETE PAD

0

- MECHANICAL & PLUMBING PLAN
- ELECTRICAL PLAN

9

DETAILS - 1

APPROVED BY:

DEPARTMENT OF PUBLIC UTILITIES ENGINEERING ASSOCIATE

DATE 2/7/2025

DEPARTMENT OF PUBLIC UTILITIES SENIOR ENGINEER


DATE 2-7-2025

DETAILS - 2

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DETAILS - 3



DEPARTMENT OF PUBLIC UTILITIES CONSTRUCTION NOTES

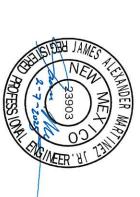CONCRETE CLASS "AA" 4000 PSI FIBER REINFORCED CONCRETE TO BE USED ON ALL PADS. AIR CONTENT FOR CONCRETE SHALL BE FOR "HIGH RISK FREEZE / THAWZONE".

VIBRATION CONTRACTOR SHALL TAKE PROPER PRECAUTIONS WHEN USING VIBRATORY EQUIPMENT AND EXERTING LOAD(S) OVER EXISTING/FRAGILE UTILITIES CONTRACTOR MAY CHOOSE TO USE STATIC COMPACTION PRACTICES OR USE ALTERNATIVE EQUIPMENT TO ACHIEVE REQUIRED DENSITY.

DAMAGES ANY CONCRETE CURB & GUTTER, SIDEWALK, DRIVEWAYS, MARKED UTILITIES, ETC. (OTHER THEN WHAT IS INTENDED FOR REMOVALS) DAMAGED BY THE CONTRACTOR WILL BE REPAIRED/REPLACED BY THE CONTRACTOR'S SOLE EXPENSE.

RIGHT-OF-WAY THE CONTRACTOR SHALL CONFINE OPERATIONS AND MATERIALS TO LOS ALAMOS COUNTY RIGHT-OF-WAY OR SPECIFIED CONSTRUCTION LIMITS OF THE PROJECT AND WILL BE HELD RESPONSIBLE FOR ANY DAMAGE CAUSED BY HIS/HER OPERATION TO PUBLIC OR PRIVATE PROPERTY, INCLUDING UTILITIES.

WORK SITE CONTRACTOR SHALL KEEP WORK SITE CLEAN IN AN ORDERLY CONDITION. DURING CONSTRUCTION, THE WORK SITE SHALL BE KEPT FREE DRAINING, AT COMPLETION OF WORK, CONTRACTOR SHALL REMOVE ALL DEBRIS AND LEAVE WORK SITE IN A CONDITION ACCEPTABLE TO THE PROJECT MANAGER.

CONCRETE CURING CONTRACTOR SHALL USE AN NMDOT APPROVED PRODUCT IN ALL FLAT WORK FINISHING. THE USE OF WATER SHALL NOT BE ALLOWED IN ANY CONCRETE FINISHING OPERATIONS. USE OF WATER SHALL BE SUBJECT TO CONCRETE REJECTION AT THE DISCRETION OF THE PROJECT MANAGER OR

THE CONTRACTOR IS RESPONSIBLE TO FIX, BACK TO THE ORIGINAL STATE, ANY STRUCTURE DAMAGED THROUGHOUT THE DURATION OF CONSTRUCTION.

LOS ALAMOS COUNTY NOISE ORDINANCE PROVISIONS THE CONTRACTOR SHALL COMPLY WITH ALL LOS ALAMOS COUNTY ORDINANCES.

CONTRACTOR SHALL PROVIDE ALL APPLICABLE SUBMITTALS PRIOR TO BEGINNING WORK

CONTRACTOR SHALL STUDY THE DRAWINGS AND THE AREAS WHERE DOMILITION WORK WILL BE PERFORMED. CORRECT CONDITIONS DETRIMENTAL TO THE COMPLETION OF THE WORK, DO NOT PROCEED UNTIL ALL UNSATISFACTORY CONDITIONS ARE CORRECTED.

COORDINATE SCHEDULING AND EXACT LOCATIONS OF TEMPORARY ENCLOSURES PRIOR TO THEIR INSTALLATION WITH THE OWNER. MAINTAIN EXISTING FIRE EXISTS DURING CONSTRUCTION OR PROVIDE TEMPORARY EXISTS AS REQUIRED.

PRIOR TO START OF DEMOLITION, THE CONTRACTOR SHALL ENSURE THAT NO AIRBORNE PARTICLES WILL INFILTARATE THE EXISTING MECHANICAL SUPPLY AND RETURN DUCTS.

CLEAN ADJACENT STRUCURES AND IMPROVEMENTS OF DUST, DIRT, AND DEBRIS CAUSED BY SELECTIVE DEMOLITION OPERATIONS

CONTRACTOR TO COORDINATE WITH THE OWNER FOR THE SALVAGE, REMOVAL, AND RE-INSTALLATION OF EQUIPMENT.

CONTRACTOR SHALL SECURE AND PAY FOR ALL PERMITS AND ASSOCIATED FEES, AS REQUIRED BY THE GOVERNING AUTHORITIES AND SHALL PAY ALL APPLICABLE TAXES.

REQUIREMENTS. CONTRACTOR/ SUBCONTRACTORS SHALL COMPLY WITH ALL APPLICABLE PROVISIONS OF LABOR REGULATION AND LAWS AS WELL AS ALL SAFETY AND HEALTH

CONTRACTOR/ SUBCONTRACTORS SHALL VISIT THE PROJECT SITE AND CAREFULLY REVIEW THE DRAWINGS PRIOR TO SUBMITTING BIDS AND SHALL BECOME FAMILIAR WITH THE DRAWINGS AND CONDITIONS AFFECTION IT WORK THROUGH NORMAL VISUAL INSPECTION. IN THE EVENT OF DISCREPANCIES OR QUESTIONS, SUBMIT WRITTEN REQUEST FOR INFORMATION DIRECTLY TO THE OWNER FOR CLARIFICATION PRIOR TO BID. CONTRACTOR SUBCONTRACTORS SHALL CALL FOR AND RECEIVE ALL NECESSARY INSPECTIONS BY THE GOVERNING AUTHORITIES DURING THE ENTIRE CONSTRUCTION PERIOD AND SHALL COMPLY WITH ALL APPLICABLE CODE FOR THE SCOPE OF WORK OF THIS PROJECT AS INDICATED IN THE CONTRACT DOCUMENTS.

CONTRACTOR/ SUBCONTRACTORS SHALL VERIFY ALL DIMENSIONS OF THE DRAWINGS WITH THE ACTUAL PROJECT SITE CONDITIONS PRIOR TO CONSTRUCTION IN THE EVENT OF DIMENSIONAL DISCREPANCIES, NOTIFY THE DESIGN PROFESSIONAL IMMEDIATELY FOR FURTHER DIRECTIONS. ANY CHANGES TO THE

IN THE EVENT OF DIMENSIONAL DISCREPANCIES, NOTIFY THE DESIGN PROFE DRAWINGS OR SPECIFICATIONS MUST HAVE THE APPROVAL OF THE OWNER.

ALL CLOSURES ARE ASSUMED AT ALL PARTITIONS, WALL CEILINGS, ROOFS AND JUNCTIONS. IF SPECIFIC CLOSURE DETAILS ARE NOT INDICATED, CONTRACTOR SHALL CONSTRUCT CLOSURE IN KEEPING WITH THE ADJACENT CONSTRUCTION OR IN KEEPING WITH THE INDUSTRY STANDARD FOR MAKING SUCH CLOSURE. ALL FINISH MATERIALS TO BE COPED IN AND AROUND STRUCTURAL ELEMENTS AND OTHER PENETRATING ITEMS IN ORDER TO MAKE A COMPLETE CLOSURE.


APPLICABLE CODES

2021 NEW MEXICO COMMERCIAL BUILDING CODE
2021 INTERNATIONAL BUILDING CODE
2021 INTERNATIONAL EXISTING BUILDING CODE
2021 NEW MEXICO EXISTING BUILDING CODE
2021NEW MEXICO EXISTING BUILDING CODE
1021NEW MEXICO ENERGY CONSERVATION CODE
1021 NEW MEXICO PLUMBING AND MECHANICAL CODE
2021 UNIFORM MECHANICAL CODE (APMO)
2017 NEW MEXICO ELECTRICAL CODE
2020 NATIONAL ELECTRIC CODE

2012 NATIONAL ELECTRICAL SAFETY CODE

SUMMARY OF QUANTITIES	ITITIES		
DESCRIPTION	REF. SHT.	REF. SHT. BID UNIT ESTIMATE	ESTIMATE
MOBILIZATION		rs	1
FLOWABLE FILL	3	SQ.FT	400
DEMOLITION OF WALLS, DOORS, AND WINDOWS	2,3	LS	1
CONCRETE PAD, CIP	6	C.Y.	26
SEWER SYSTEM	7	Sı	1
WATER SYSTEM	7	Sı	1
ELECTRICAL SYSTEM	∞	S	1
BATHROOM INSTALLATION, CIP	3	Sı	1
OFFICE EXPANSION, CIP	3	S	1
FIREWALL	2	ŀ	45
2-HOUR FIRE RATED DOOR, CIP	2	EACH	1
AMNA LYBH	8	EACH	1
GUARDRAIL, FURNISHED BY OWNER	2	ŀ	35
MOVE HEAVY EQUIPMENT TO STAGING AREA		LS	1

VICINITY MA

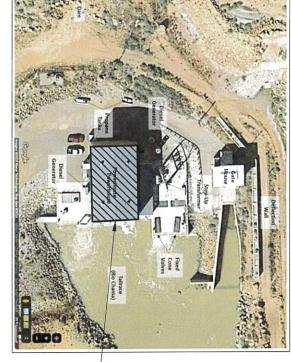

PROJECT SITE POWERHOUSE BUILDING



CODE INFORMATION

OCCUPANCY TYPE......
TOTAL BUILDING SQUARE FOOTAGE......
OFFICE RENOVATION SQUARE FOOTAGE. ..GROUP U ..12,300 SQUARE FEET ..400 SQUARE FEET

BUILDING FLOOR AREA
NO CHANGE IN BUILDING FLOOR AREA

NUMBER OF STORIES

EXISTING USE AND OCCUPANCY GROUP U

CLASSIFICATION OF WORK PER IEBC ALTERATIONS - LF NO CHANGE TO OCCUPANCY USE

PER IEBC ALTERATIONS - LEVEL 2
RENOVATED AREAS ARE LESS THAN 50% OF THE BUILDING AREA

ALTERATIONS INCLUDE THE REMOVAL AND CONSTRUCTION OF NEW INTERIOR WALLS, A FIRST FLOOR BATHROOM ADDITION, FIREWALL CONSTRUCTION AND DOOR REPLACEMENT, ALONG WITH A NEW HYAC SYSTEM AND CONCRETE PAD, MISCELLANEOUS WORK INCLUDES THE RELOCATION OF ~10,000LBS OF MATERIAL AND THE INSTALLATION OF 35' OF OWNER FURNISHED GUARDRAILS.

NO CHANGE TO EGRESS ROUTE. NO CHANGE TO EGRESS DISTANCE

FIRE ALARM SYSTEM
SMOKE DETECTORS. NO FIXED FIRE SUPPRESSION SYSTEM.

PLUMBING INFORMATION
TWO NEW FIXTURES. SEE SHEET 7





ABIQUIU OFFICE EXPANSION


GENERAL NOTES

DESIGNED BY:	SH
DRAWN BY:	SH
APPROVED BY:	JAM
DATE: <u>2/7/20</u>	025
SCALE:	

NO.	REVISION DESCRIPTION
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INCORPORATED COUNTY OF LOS ALAMOS DEPARTMENT OF PUBLIC UTILITIES 1000 CENTRAL AVE., SUITE 130 LOS ALAMOS, NEW MEXICO 87544

(505) 662-8150 FAX: (505) 662-8109

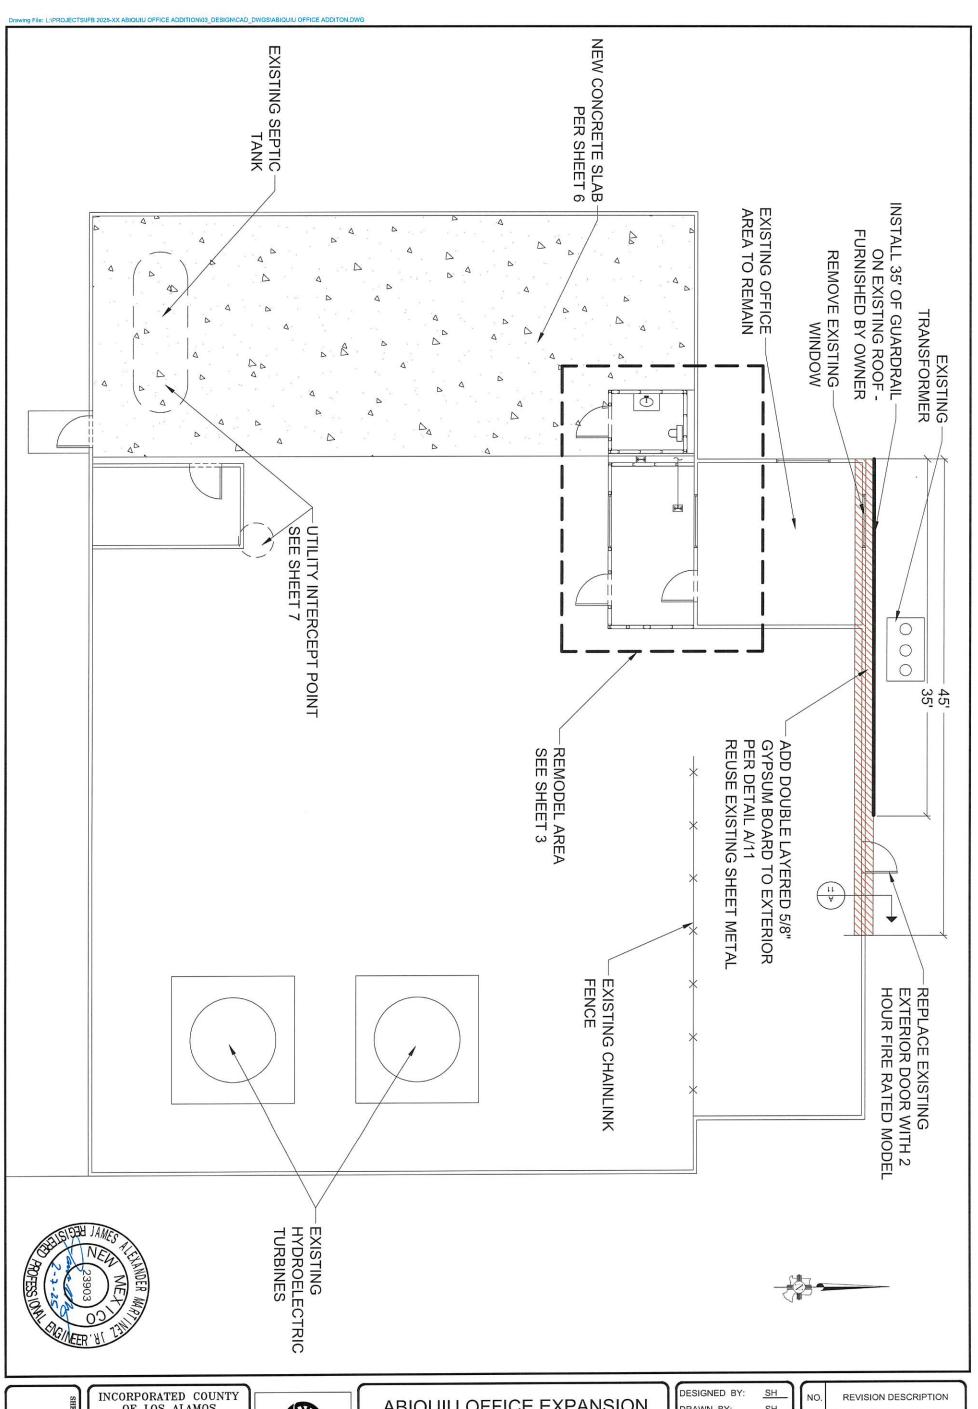

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INCORPORATED COUNTY
OF LOS ALAMOS

DEPARTMENT OF PUBLIC UTILITIES
1000 CENTRAL AVE., SUITE 130
LOS ALAMOS, NEW MEXICO 87544


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LOS ALAMOS

ABIQUIU OFFICE EXPANSION
REFLECTED OVERVIEW

DESIGNED BY:	SH
DRAWN BY:	SH
APPROVED BY:	JAM
DATE: 2/7/2	025
SCALE: 1/4" =	1'-0"

REVISION DESCRIPTION



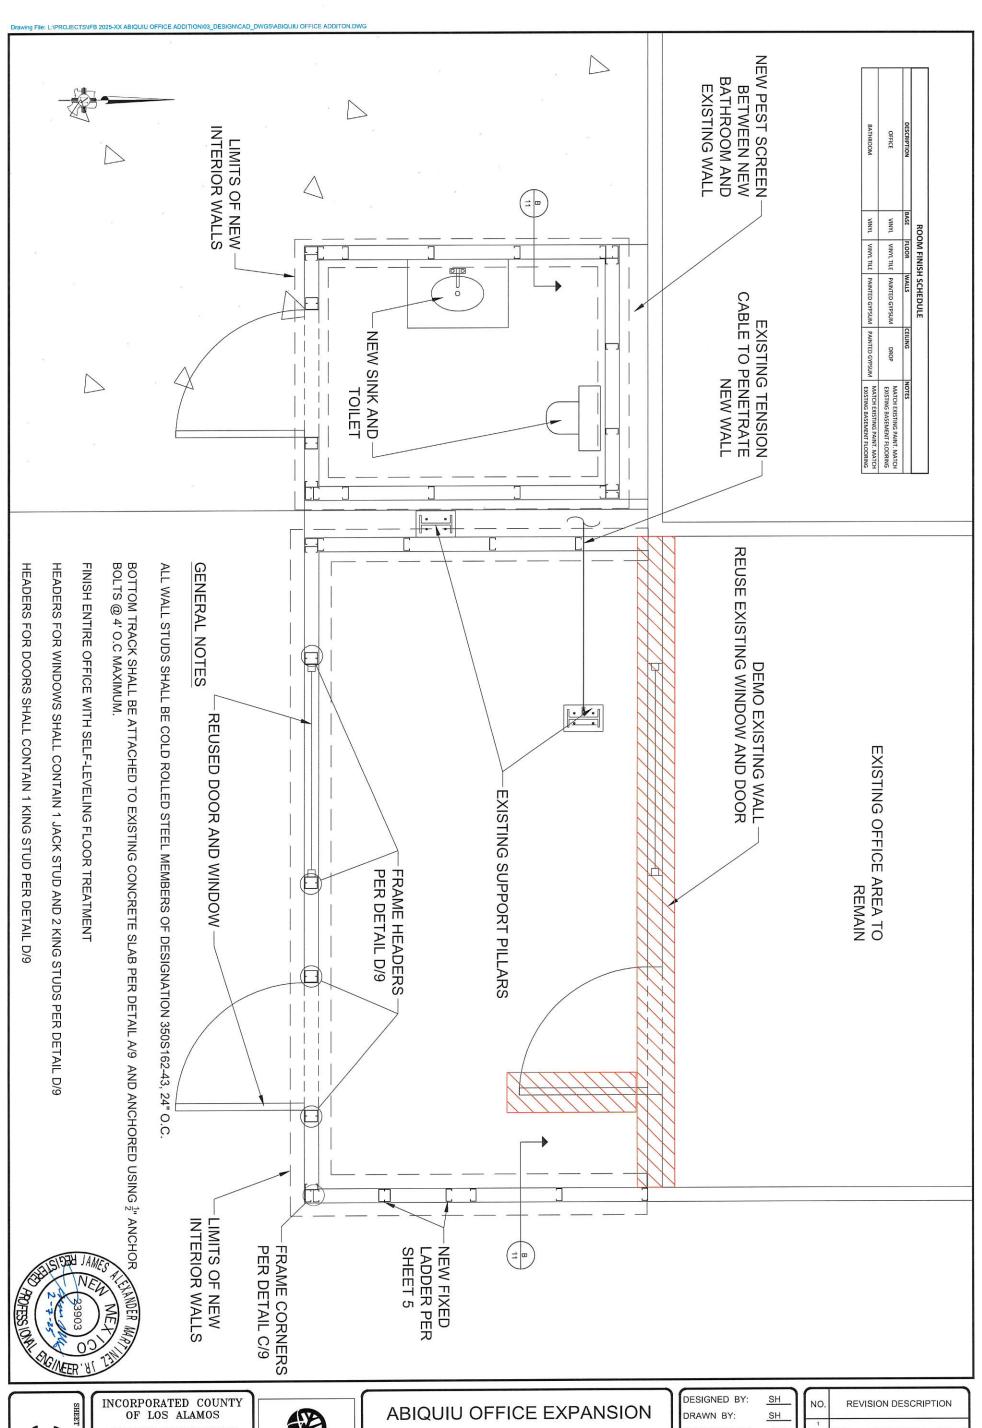

DEPARTMENT OF PUBLIC UTILITIES 1000 CENTRAL AVE., SUITE 130 LOS ALAMOS, NEW MEXICO 87544


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ABIQUIU OFFICE EXPANSION
PROPOSED FLOOR PLAN

DESIGNED I	BY:	SH
DRAWN BY:		SH
APPROVED	BY:	JAM
DATE:	2/7/20:	25
SCALE: _	1" = 1'-0)"

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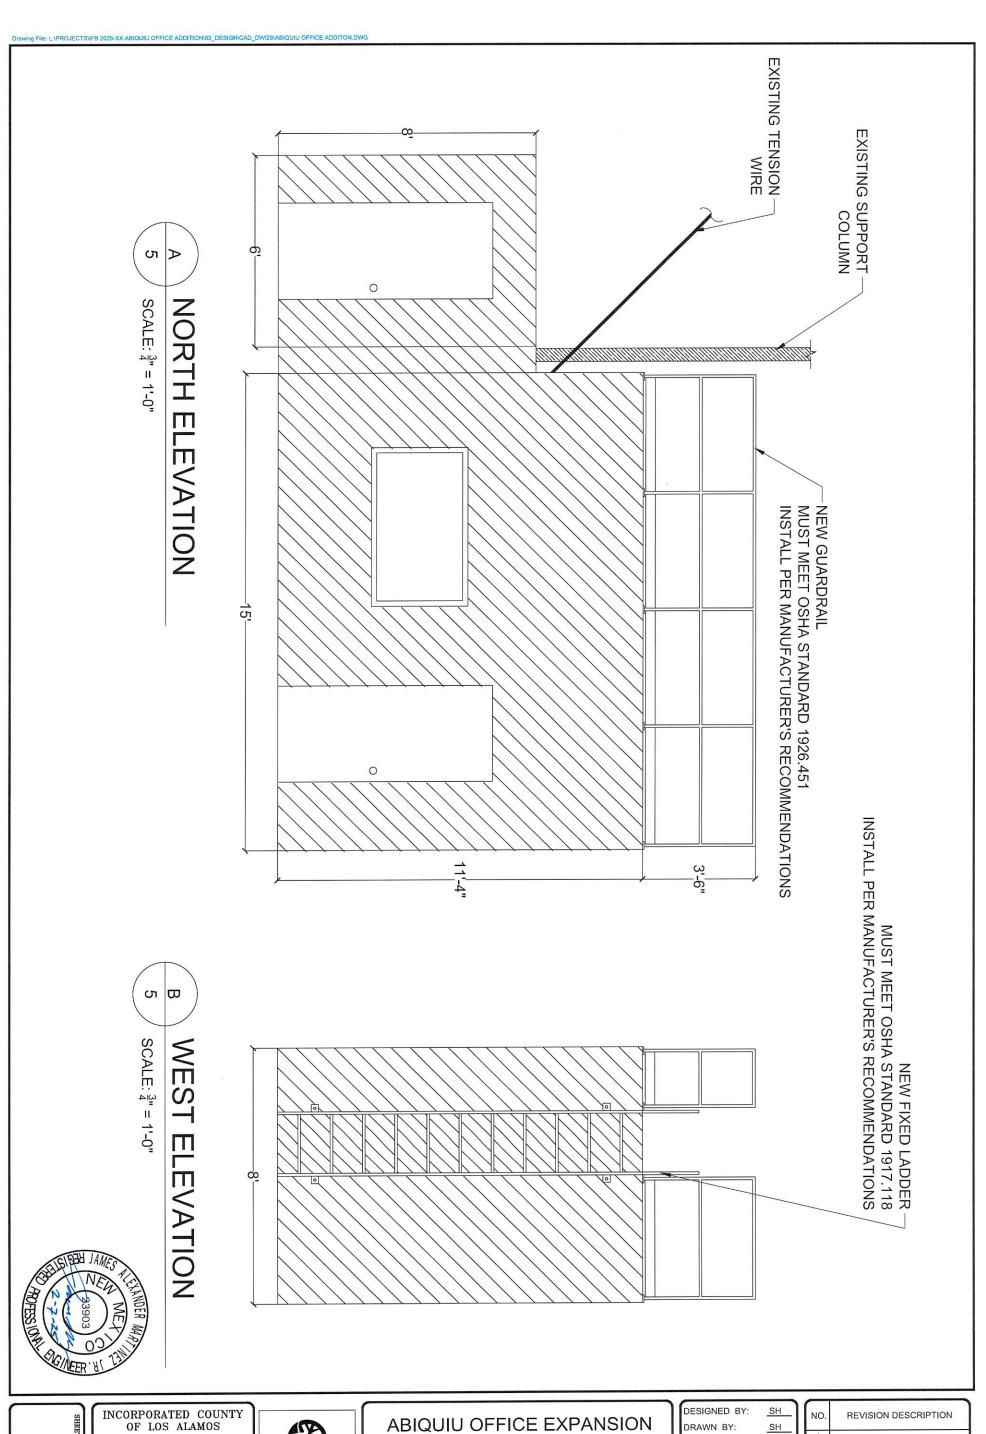


ABIQUIU OFFICE EXPANSION

ROOFING PLAN
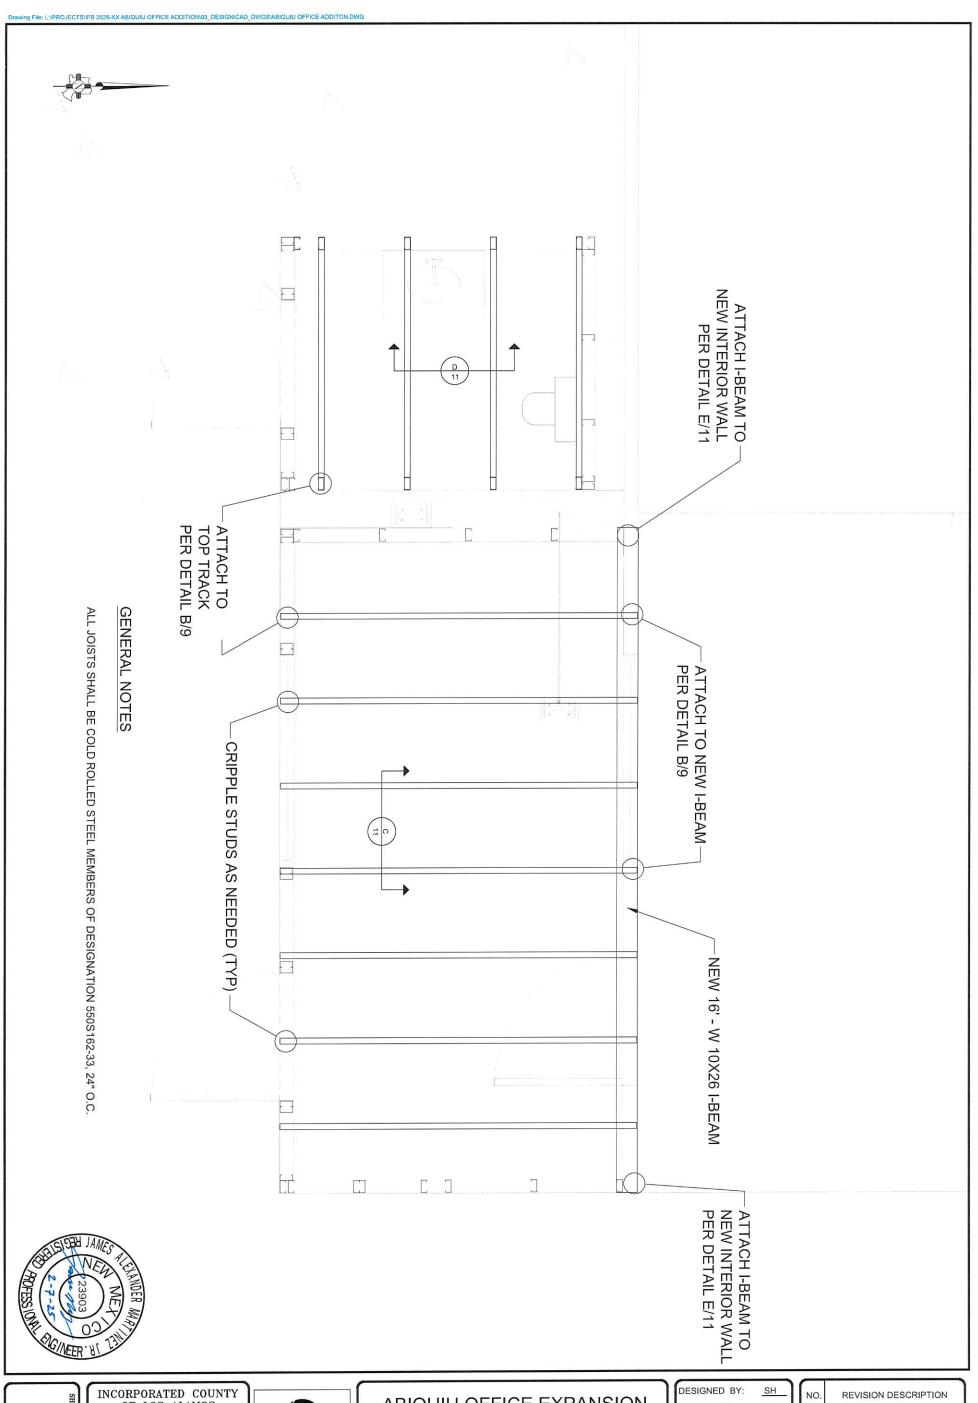
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DRAWN BY		SH
APPROVED	BY:	JAM
DATE:	2/7/20:	25
SCALE: _	1" = 1'-0"]

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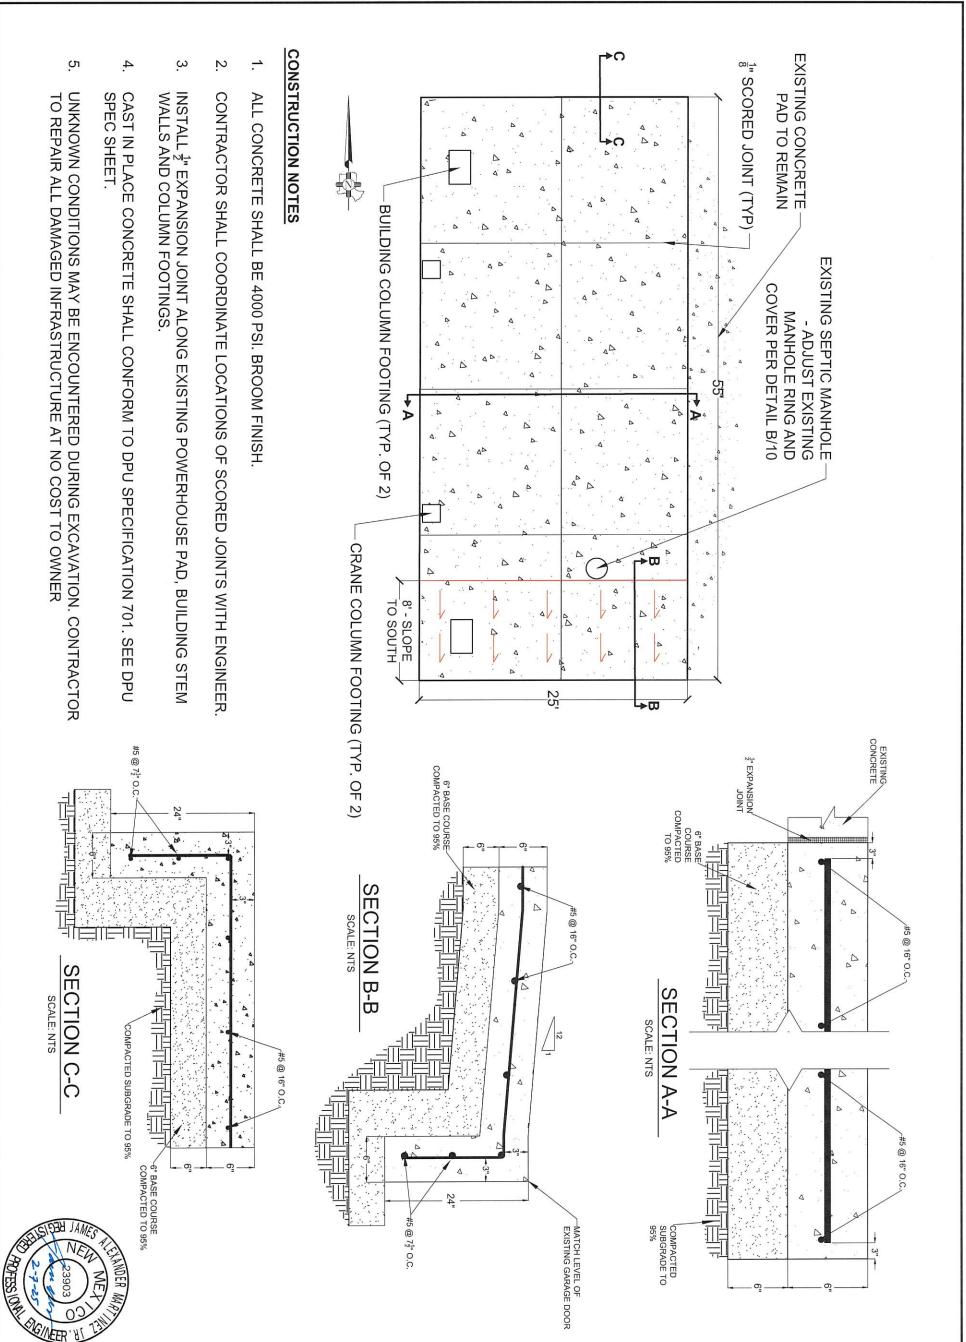
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ELEVATIONS

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APPROVED BY:	JAM
DATE: 2/7/20	025
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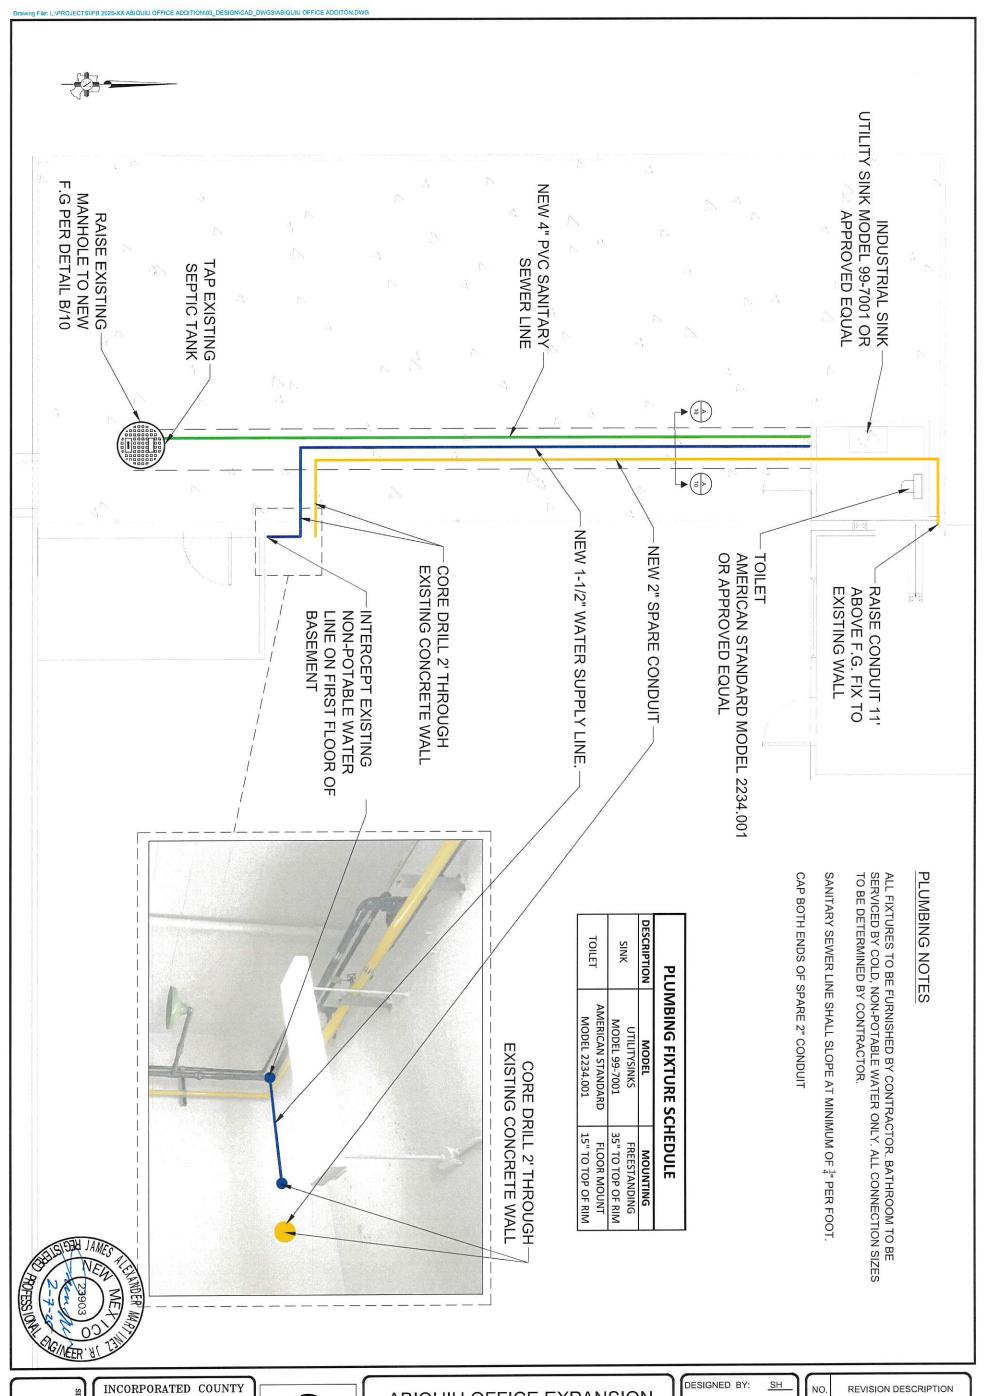


ABIQUIU OFFICE EXPANSION

CONCRETE PAD

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DRAWN BY	:	SH
APPROVED	BY:	JAM
DATE:	2/7/20:	25
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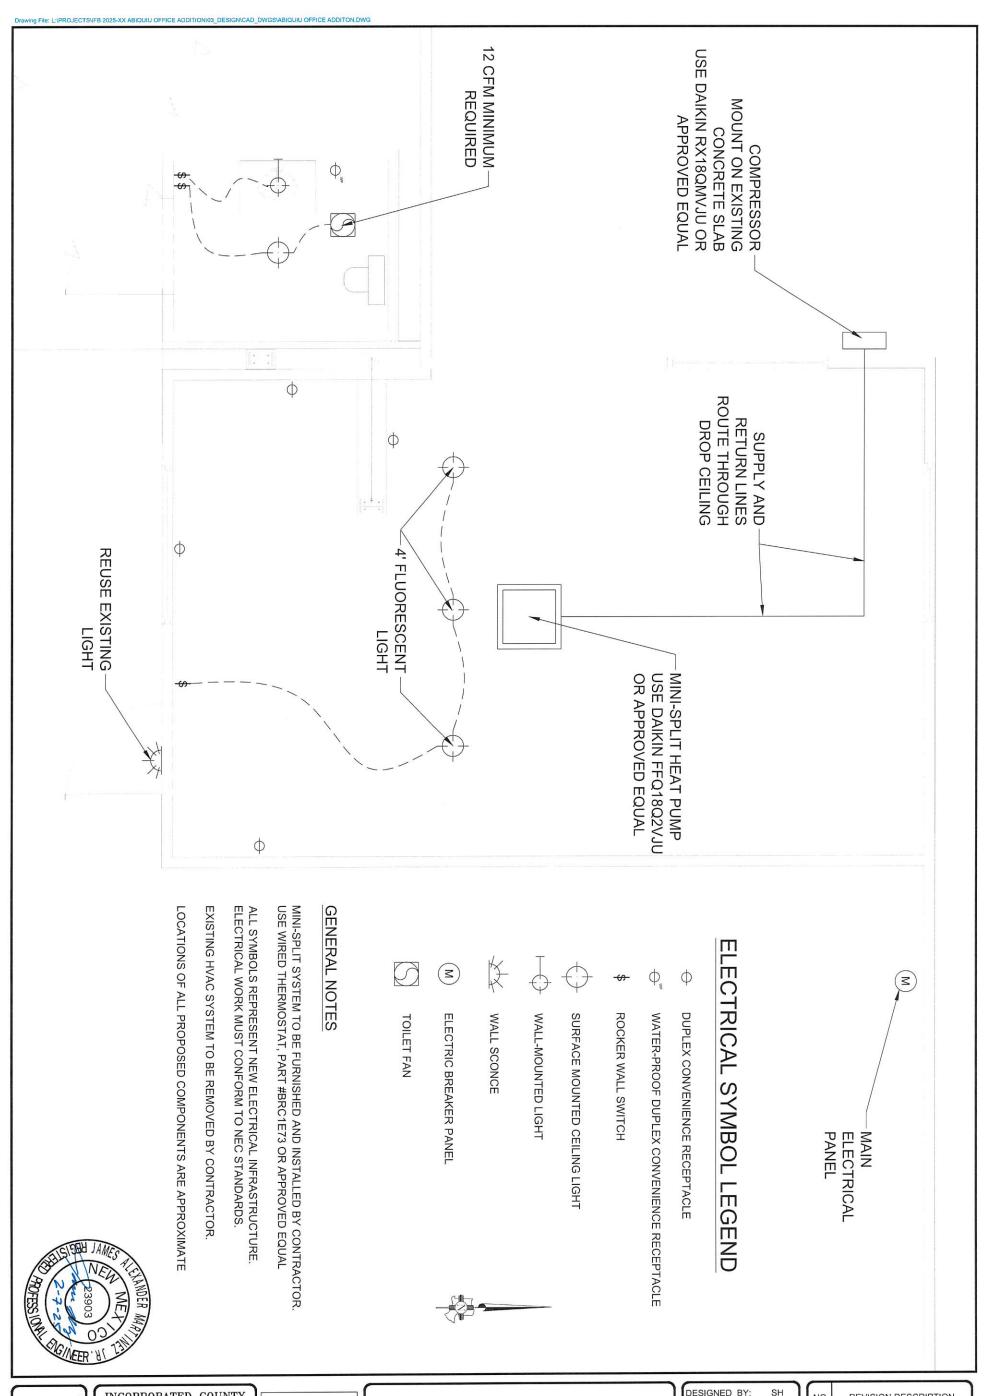


ABIQUIU OFFICE EXPANSION

MECHANICAL & PLUMBING PLAN

DESIGNED BY:	SH
DRAWN BY:	SH
APPROVED BY:	JAM
DATE: 2/7/2	2025
SCALE:3/8" =	1'-0"

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ABIQUIU OFFICE EXPANSION

ELECTRICAL PLAN

DESIGNED	BY:	SH
DRAWN BY	:	SH
APPROVED	BY:	JAM
DATE:	2/7/20	25
SCALE:	3/4" =	1'-0"

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Drawing File: L:\PROJECTS\IFB 2025-XX ABIQUIU OFFICE ADDITION\03_DESIGN\CAD_DWGS\ABIQUIU OFFICE ADDITON.DWG TRACK CLIP TRACK FLANGE AT LAP JOINT 9 C 9 A CORNERS SCALE: NTS SCALE: NTS FLOOR ANCHOR STUD NO. 6 SCREWS SILL SEALER AS REQUIRED 2 NO. 8 SCREWS

@ 24* O.C. CONNECTING
CORNER STUDS 4 NO. B SCREWS AT LAPPED TRACK WALL STUD -TRACK WALL BOARD FINISH NO. 8 SCREW THROUGH EACH FLANGE STUD BLOCKING INSIDE WALL TRACK (MINIMUM THICKNESS OF STUD) 4 NO. 8 SCREWS THROUGH EACH FLANGE ANCHOR BOLT OR OTHER CONNECTION AS REQUIRED FOUNDATION OR SLAB ON GRADE ALTERNATE PLAN TRACK-TRACK-NO. 8 SCREWS THROUGH — JOIST FLANGE, CLIP ANGLE OR BENT STIFFENER WEB STIFFENER CRIPPLE STUD (MIN. 33 MIL THICK) FASTEN RIM TRACK TO — WALL TRACK WITH NO. 8 SCREWS AT 24 IN. O.C. TRACK C-SHAPES 2 NO 8 SCREWS AT-24" ON CENTER, ONE PER FLANGE 2 NO.8 SCREWS @ 24" O.C. ONE PER FLANGE 9 B 9 SCALE: NTS TOP TRACK SCALE: NTS **HEADERS** - NO. 8 SCREWS THROUGH SHEATHING TO EACH JACK AND KING STUD AT 12" ON CENTER - TRACK OR C-SHAPE
ATTACH WITH NO 8 SCREWS
(MINIMUM DEPTH = HEADER
DEPTH MINUS ⅓ INCH) NO. 8 SCRE STRUCTURAL SHEATHING TRACK LOAD-BEARING STUD KING STUD(S) JACK STUD(S) EW THROUGH NGE JOIST SHEATHING



INCORPORATED COUNTY OF LOS ALAMOS

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ABIQUIU OFFICE EXPANSION

DETAILS - 1

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APPROVED BY:	JAM
DATE: <u>2/7/2</u>	025
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SCALE: NTS

SHARED

TRENCH

- 5 4 3 2 3
- NOTES:


 DW IS THE OUTSIDE WATER PIPE DIAMETER IN INCHES.

 DS IS THE OUTSIDE SEWER PIPE DIAMETER IN INCHES.

 SEE COMPACTION SPECIFICATIONS (SECTION 202) FOR ALL REQUIREMENTS.

 TRENCH WIDTH SHALL BE DISTANCE FROM OUTSIDE FACE OF OUTER MOST PIPES PLUS 6 INCHES.

 2" SPARE RIDGED CONDUIT. MUST MAINTAIN 12" SEPARATION FROM OTHER LINES.

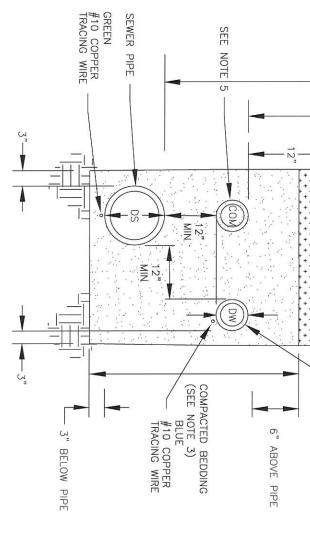

M 48. COMPACTED BACKFILL SEWER (SEE NOTE 3)
WARNING TAPE FINISHED GRADE 36" WATER
WARNING TAPE PEX WATER LINE

12" MAX

V

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ADJUSTING RINGS

NON-SHRINK GROUT —/
3/8" MINIMUM THICKNESS AT JOINTS

-BUTYL JOINT SEALANT

NOTES: 1.) ALL SHIMS REQUIRE DPU APPROVAL. SHIMS IF USED ARE REQUIRED TO BE METAL AND WITH BUTYL JOINT SEALER. NEED TO BE GROUTED AND SEALED

MANHOLE COVER ADJUSTMENT

10

SCALE: NTS

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ABIQUIU OFFICE EXPANSION

DETAILS - 2

DESIGNED BY:	SH
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APPROVED BY	: JAM
DATE:2/7	7/2025
SCALE:	

NON-SHRINK GROUT
3/8" MINIMUM THICKNESS AT JOINTS
1" MINIMUM THICKNESS EXPOSED EDGE

SHIMS IF USED, SHALL BE CARBON STEEL SIZED AND PLACED TO AVOID UNBALANCED MOVEMENT OF THE RING, HAVE BUTYL JOINT SEALANT AND BE FULLY GROUTED.

MINIMUM

NO.	REVISION DESCRIPTION
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CASTING



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ABIQUIU OFFICE EXPANSION

DETAILS - 3

DESIGNED BY:	SH
DRAWN BY:	SH
APPROVED BY:	JAM
DATE: <u>2/7/2</u>	025
SCALE:	

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